

**February 1, 2023** 

### **ADDENDUM NO. 1**

HVAC UPGRADES – LAUDERDALE COUNTY, MS MERIDIAN, MS ERG P.N. 21.006



I. Bidder acknowledges that it is Bidder's responsibility to ascertain whether any Addenda have been issued and if so, to obtain copies of such Addenda. Bidder therefore agrees to be bound by all Addenda that have been issued for this Bid.

This Addendum forms a part of the Contract Documents and modifies the original Bidding Documents and consists of 3 pages (plus attachments). The following clarifications, changes, additions, or deletions shall be made to the following documents as indicated, and all other conditions shall remain the same.

### II. PERTAINING TO THE SPECIFICATIONS

Item 1.	Reference:	004113 – BID PROPOSAL FORM
	Scope:	Replace the Bid Proposal Form with the attached Bid
		Proposal Form.
		Added Lines for Additive Alternate No. 1 and Additive Alternate No. 2.
		Clarification:
		Base Bid Scope: All work associated with the Human Services Building.
		Additive Alternate No. 1 Scope: All work associated with the Emergency Services / EMA Building.
		Additive Alternate No. 2 Scope: All work associated with the Agri-Center.



### III. PERTAINING TO THE DRAWINGS

Item 2.	Reference:	Sheet T0.1				
	Scope:	Revise Project Summary to the following:				
		HUMAN SERVICES				
		BASE BID				
		<ul> <li>DEMOLITION OF CEILING</li> <li>DEMOLITION OF HVAC AND CONTROL SYSTEM</li> <li>INSTALLATION OF NEW HVAC AND CONTROL SYSTEMS</li> <li>INSTALLATION OF NEW CEILING, PATCHING AND PAINTING</li> <li>ELECTRICAL SYSTEMS DEMOLITION AND SERVICE TO NEW EQUIPMENT</li> </ul>				
		EMERGENCY SERVICES / EMA				
		ADD ALTERNATE #1				
		<ul> <li>DEMOLITION OF CEILINGS WHERE SHOWN</li> <li>DEMOLITION OF VAV UNITS AND CONTROL SYSTEM INCLUDING PNEUMATIC CONTROLS NO LONGER IN SERVICE.</li> <li>INSTALLATION OF NEW VAV UNITS AND CONTROL SYSTEM</li> <li>INSTALLATION OF NEW CEILING WHERE SHOWN, PATCHING AND PAINTING</li> <li>ELECTRICAL SYSTEMS DEMOLITION AND SERVICE TO NEW EQUIPMENT</li> </ul>				
		AGRI-CENTER				
		ADD ALTERNATE #2				
		<ul> <li>DEMOLITION OF LOWER RESTROOM CEILINGS</li> <li>INSTALLATION OF NEW HVAC SYSTEM</li> <li>INSTALLATION OF LOWER RESTROOM NEW CEILINGS, PATCHING AND PAINTING</li> <li>ELECTRICAL SYSTEMS DEMOLITION AND SERVICE TO NEW</li> </ul>				



		EQUIPMENT					
Item 3	Reference:	Electrical Drawings					
	Scope:	Add the following attached Electrical Drawings.					
		<ul> <li>E0.1 Electrical Symbols Legend</li> <li>E0.2 Electrical Schedules &amp; Details</li> <li>E1.1 Human Services Bldg. Electrical 1st Floor Plan</li> <li>E1.2 Human Services Bldg. Electrical 2nd Floor Plan</li> <li>E1.3 Human Services Bldg. Electrical Schedules &amp; Details</li> <li>E2.1 Emergency Services Bldg. Electrical 1st Floor Plan</li> <li>E2.2 Emergency Services Bldg. Electrical 2nd Floor Plan</li> <li>E3.1 Agri-Center Bldg. Electrical Upper Level Plan</li> <li>E3.2 Agri-Center Bldg. Electrical Lower Level Plan</li> </ul>					

### IV. PRE-BID CONFERNCE

Item 4.	Reference:	Pre-Bid Conference			
	Scope:	A pre-bid conference was held on Thursday 01/19/2023 at			
		10:00 am. Minutes from the meeting are included as an			
		attachment to the addendum.			

# **END OF ADDENDUM NO. 1**

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# L.V. ELECTRICAL EQUIPMENT SYMBOLS LEGEND BRANCH CIRCUIT PANELBOARD, SURFACE MOUNT, 208Y/120 VOLT SYSTEM. BRANCH CIRCUIT PANELBOARD, DOUBLE SECTION, SURFACE MOUNT, 208Y/120 VOLT SYSTEM. BRANCH CIRCUIT PANELBOARD, SURFACE MOUNT, 480Y/277 VOLT SYSTEM. BRANCH CIRCUIT PANELBOARD, DOUBLE SECTION, SURFACE MOUNT, 480Y/277 VOLT SYSTEM. POWER OR SMALL DISTRIBUTION PANELBOARD, SURFACE MOUNT, 208Y/120 VOLT SYSTEM. POWER OR SMALL DISTRIBUTION PANELBOARD, SURFACE MOUNT, 480Y/277 VOLT SYSTEM. DISTRIBUTION PANELBOARD, SURFACE MOUNT, 208Y/120 VOLT SYSTEM. DISTRIBUTION PANELBOARD, SURFACE MOUNT, 480Y/277 VOLT SYSTEM. SWITCHBOARD, FREE STANDING WITH HOUSE KEEPING PAD, SERVICE ENTRANCE RATED, ELECTRICAL CHARACTERISTICS AS INDICATED OR SCHEDULED.. TRANSFORMER, DRY-TYPE, KVA & VOLTAGE RATINGS AS INDICATED, FLOOR MOUNTED ON NEOPRENE PADS UNLESS INDICATED OTHERWISE. ENCLOSED CIRCUIT BREAKER, NEMA RATED ENCLOSURE AS INDICATED OR REQUIRED FOR INSTALLED ENVIRONMENT, ELECTRICAL CHARACTERISTICS AS INDICATED, SURFACE MOUNT C.L. UP 54" A.F.F. UNLESS SWITCH, UNFUSED SAFETY DISCONNECT, AMPERE RATING, NUMBER OF POLES, PROPER VOLTAGE RATING FOR BRANCH CIRCUIT, SURFACE MOUNT C.L. UP 54" A.F.F. UNLESS INDICATED OTHERWISE. SWITCH, UNFUSED SAFETY DISCONNECT, NEMA 3R RATED, AMPERE RATING, NUMBER OF POLES, PROPER VOLTAGE RATING FOR BRANCH CIRCUIT, MOUNT C.L. UP 54" A.F.F. UNLESS INDICATED OTHERWISE. SWITCH, FUSED SAFETY DISCONNECT, AMPERE RATING, NUMBER OF POLES, PROPER VOLTAGE RATING FOR BRANCH CIRCUIT, SURFACE MOUNT C.L. UP 54" A.F.F. UNLESS INDICATED OTHERWISE. SWITCH, FUSED SAFETY DISCONNECT, NEMA 3R RATED, AMPERE RATING, NUMBER OF POLES, PROPER VOLTAGE RATING FOR BRANCH CIRCUIT, MOUNT C.L. UP 54" A.F.F. UNLESS INDICATED OTHERWISE. DISCONNECT SWITCH, TOGGLE SWITCH TYPE WITH OUTLET BOX & PLATE, 20A1P, 120/277V, FLUSH MOUNT C.L. UP 48" A.F.F. UNLESS INDICATED OTHERWISE. DISCONNECT SWITCH, TOGGLE SWITCH TYPE WITH OUTLET BOX & PLATE, 20A2P, 120/277V, FLUSH MOUNT C.L. UP 48" A.F.F. UNLESS INDICATED OTHERWISE. **EMERGENCY POWER SYSTEM SYMBOLS LEGEND** DIESEL ENGINE GENERATOR WITH SUB-BASE FUEL TANK, WEATHER HOUSING & CONCRETE PAD, KW/KVA & VOLTAGE RATINGS AS INDICATED, VERIFY LOCATION, ORIENTATION, ETC. WITH PROFESSIONAL PRIOR TO GASEOUS ENGINE GENERATOR WITH WEATHER HOUSING & CONCRETE PAD, KW/KVA & VOLTAGE RATINGS AS INDICATED, VERIFY LOCATION, ORIENTATION, ETC. WITH PROFESSIONAL PRIOR TO ROUGH-IN. AUTOMATIC TRANSFER SWITCH, NEMA 1 ENCLOSURE, AMPERE RATING & NUMBER OF POLES AS INDICATED, SURFACE MOUNT, "LS" INDICATES LIFE SAFETY BRANCH, "CR" INDICATES CRITICAL BRANCH, "EQ" INDICATES MANUAL TRANSFER SWITCH, NEMA 1/3R ENCLOSURE AS INDICATED, AMPERE RATING & NUMBER OF POLES AS INDICATED, SURFACE MOUNT. 3-WAY MANUAL TRANSFER SWITCH/DOCKING STATION, NEMA 3R ENCLOSURE AS INDICATED, AMPERE RATING & NUMBER OF POLES AS INDICATED, SURFACE MOUNT. ENGINE GENERATOR REMOTE ALARM PANEL, FLUSH MOUNT C.L. UP 54" A.F.F. OR AS DIRECTED, VERIFY LOCATION PRIOR TO ROUGH-IN. ENGINE GENERATOR REMOTE ALARM PANEL, SURFACE MOUNT C.L. UP 54" A.F.F. OR AS DIRECTED, VERIFY LOCATION PRIOR TO ROUGH-IN. ENGINE GENERATOR REMOTE EMERGENCY POWER OFF PUSHBUTTON STATION, SEMI-FLUSH MOUNT C.L. UP 48"

	ELECTRICAL ABBREVIATIONS
A.A.C.	ADJACENT TO ANY SYMBOL DENOTES DEVICE/OUTLET INSTALLED ABOVE ACCESSIBLE CEILING.
A.F.F.	DENOTES "ABOVE THE FINISHED FLOOR".
A.F.G.	DENOTES "ABOVE THE FINISHED GRADE".
B.F.G.	DENOTES "BELOW THE FINISHED GRADE".
GFI	ADJACENT TO ANY DEVICE OUTLET SYMBOL DENOTES DEVICE IS GROUND-FAULT INTERRUPTER TYPE.
WP	ADJACENT TO ANY OUTLET SYMBOL DENOTES DEVICE/OUTLET & INSTALLATION IS WEATHER PROOF.
CLG	ADJACENT TO ANY OUTLET SYMBOL DENOTES DEVICE/OUTLET IS FLUSH IN CEILING, VERIFY LOCATION WITH PROFESSIONAL PRIOR TO ROUGH—IN.
SOF	ADJACENT TO ANY OUTLET SYMBOL DENOTES DEVICE/OUTLET IS MOUNTED FLUSH IN SOFFIT, VERIFY LOCATION WITH PROFESSIONAL PRIOR TO ROUGH—IN.
SURF	ADJACENT TO ANY OUTLET SYMBOL DENOTES DEVICE/OUTLET IS SURFACE MOUNTED USING SURFACE METAL RACEWAYS & BOXES, VERIFY ROUTING WITH ARCHITECT PRIOR TO ROUGH—IN.
ROOF	ADJACENT TO ANY OUTLET SYMBOL DENOTES DEVICE/OUTLET/CONNECTION IS ON THE ROOF, VERIFY LOCATION WITH PROFESSIONAL PRIOR TO ROUGH—IN.
EXG	ADJACENT TO ANY SYMBOL DENOTES OUTLET/DEVICE/EQUIPMENT IS EXISTING, LOCATION SHOWN IS APPROXIMATE & REPRESENTATIVE, SITE VERIFY EXISTING CONDITIONS.
REL	ADJACENT TO ANY SYMBOL DENOTES EXISTING OUTLET/DEVICE/EQUIPMENT TO BE RELOCATED AS INDICATED, LOCATION SHOWN IS APPROXIMATE & REPRESENTATIVE, SITE VERIFY EXISTING CONDITIONS.

A.F.F. OR AS DIRECTED.

# POWER RACEWAYS & BOXES SYMBOLS LEGEND

BRANCH CIRCUIT (CONDUIT & WIRING) CONCEALED ABOVE CEILING OR IN WALL, NUMBER OF CONDUCTORS, (V) --///V INDICATES EQUIP. GROUNDING CONDUCTOR SIZED PER BRANCH CIRCUIT UNLESS INDICATED OTHERWISE. BRANCH CIRCUIT (CONDUIT & WIRING) CONCEALED IN/UNDER FLOOR SLAB PER THE SPECS. OR BELOW THE FINISHED GRADE PER THE SPECS., NUMBER OF CONDUCTORS WITH EQUIPMENT GROUNDING CONDUCTOR (V). BRANCH CIRCUIT (CONDUIT & WIRING) EXPOSED ON CEILING ONLY UNLESS INDICATED OTHERWISE, NUMBER OF CONDUCTORS WITH EQUIPMENT GROUNDING CONDUCTOR (V). BRANCH CIRCUIT (CONDUIT & WIRING), FLEXIBLE METALLIC CONDUIT (FMC) UNLESS INDICATED OTHERWISE, NUMBER OF CONDUCTORS WITH EQUIPMENT GROUNDING CONDUCTOR (V).

BRANCH CIRCUIT (CONDUIT & WIRING), LIQUID-TIGHT FLEXIBLE METALLIC CONDUIT (LFMC), NUMBER OF CONDUCTORS WITH EQUIPMENT GROUNDING CONDUCTOR (V).

1/1/-H-

BRANCH CIRCUIT(S) (CONDUIT & WIRING) HOMERUN, PANEL & CIRCUIT DESIGNATION(S), ROUTE CONCEALED, NUMBER OF CONDUCTORS, (V) INDICATES EQUIPMENT GROUNDING CONDUCTOR, MINIMUM 3/4" CONDUIT, ALL HOMERUNS GREATER THAN 75 FT. IN LENGTH SHALL USE MINIMUM #10 AWG CONDUCTORS.

NUMBER OF CONDUCTORS, (V) INDICATES EQUIPMENT GROUNDING CONDUCTOR, MINIMUM 3/4" CONDUIT, ALL HOMERUNS GREATER THAN 75 FT. IN LENGTH SHALL USE MINIMUM #10 AWG CONDUCTORS. BRANCH CIRCUIT(S) (CONDUIT & WIRING) HOMERUN, PANEL & CIRCUIT DESIGNATION(S), ROUTE CONCEALED IN/UNDER FLOOR SLAB OR BELOW FINISHED GRADE PER THE SPECS. NUMBER OF CONDUCTORS, (V) INDICATES

EQUIPMENT GROUNDING CONDUCTOR, MINIMUM 3/4" CONDUIT, ALL HOMERUNS GREATER THAN 75 FT. IN

BRANCH CIRCUIT(S) (CONDUIT & WIRING) HOMERUN, PANEL & CIRCUIT DESIGNATION(S), ROUTE EXPOSED,

SURFACE JUNCTION BOX WITH COVER, SIZE & MOUNTING HEIGHT AS INDICATED, MINIMUM BOX SIZE SHALL BE

LENGTH SHALL USE MINIMUM #10 AWG CONDUCTORS.

4" SQUARE. FLUSH JUNCTION BOX WITH PLATE, SIZE & MOUNTING HEIGHT AS INDICATED, MINIMUM BOX SIZE SHALL BE 4" SQUARE WITH 1 GANG RAISED COVER.

BRANCH CIRCUIT HOMERUN JUNCTION BOX, 4" SQUARE MINIMUM, MOUNT ABOVE ACCESSIBLE CEILING WHERE PRESENT, AT OVERHEAD STRUCTURE OR AS INDICATED.

BRANCH CIRCUIT HOMERUN JUNCTION BOX, EMERGENCY POWER SYSTEM, 4" SQUARE MINIMUM, MOUNT ABOVE ACCESSIBLE CEILING WHERE PRESENT, AT OVERHEAD STRUCTURE OR AS INDICATED.

# WIRING DEVICES SYMBOLS LEGEND

GROUNDING RECEPTACLE WITH BOX, PLATE & BRANCH CIRCUIT, 120 VOLTS, NEMA 5-20R, MOUNT C.L. UP 18" A.F.F. UNLESS OTHERWISE INDICATED, CIRCUIT DESIGNATION.

DUPLEX GROUNDING RECEPTACLE WITH BOX, PLATE & BRANCH CIRCUIT, 120 VOLTS, NEMA 5-20R, MOUNT C.I UP 18" A.F.F. UNLESS OTHERWISE INDICATED, CIRCUIT DESIGNATION.

DUPLEX GROUNDING RECEPTACLE WITH BOX, PLATE & BRANCH CIRCUIT, 120 VOLTS, NEMA 5-20R, MOUNT C.L UP 4" ABOVE COUNTER/BACKSPLASH UNLESS OTHERWISE INDICATED, CIRCUIT DESIGNATIONS.

DOUBLE DUPLEX GROUNDING RECEPTACLES WITH BOX, PLATE & BRANCH CIRCUIT, 120 VOLTS, NEMA 5-20R, MOUNT C.L. UP 18" A.F.F. UNLESS OTHERWISE INDICATED, CIRCUIT DESIGNATION.

DUPLEX GROUNDING RECEPTACLE WITH BOX, PLATE & BRANCH CIRCUIT, G.F.I. TYPE, 120 VOLTS, NEMA 5-20R, MOUNT C.L. UP 18" A.F.F. UNLESS OTHERWISE INDICATED, CIRCUIT DESIGNATION.

DUPLEX GROUNDING RECEPTACLE WITH BOX, PLATE & BRANCH CIRCUIT, G.F.I. TYPE, 120 VOLTS, NEMA 5-20R, MOUNT C.L. UP 4" ABOVE COUNTER/BACKSPLASH WHERE PRESENT OR C.L. UP 48" A.F.F. UNLESS OTHERWISE INDICATED, CIRCUIT DESIGNATION.

DUPLEX GROUNDING RECEPTACLE WITH BOX, WEATHERPROOF COVER & BRANCH CIRCUIT, G.F.I. TYPE, 120 VOLTS, NEMA 5-20R, MOUNT C.L. UP 18" A.F.F. UNLESS NOTED OTHERWISE, CIRCUIT DESIGNATION.

DUPLEX GROUNDING RECEPTACLE WITH BOX, PLATE & EMERGENCY-POWER BRANCH CIRCUIT, RED DEVICE, 120 VOLTS, NEMA 5-20R, MOUNT C.L. UP 18" A.F.F. UNLESS OTHERWISE INDICATED, CIRCUIT DESIGNATION.

DOUBLE DUPLEX GROUNDING RECEPTACLE WITH BOX, PLATE & EMERGENCY-POWER BRANCH CIRCUIT, RED DEVICE, 120 VOLTS, NEMA 5-20R, MOUNT C.L. UP 18" A.F.F. UNLESS OTHERWISE INDICATED, CIRCUIT

DESIGNATION. GROUNDING RECEPTACLE WITH BOX. PLATE & BRANCH CIRCUIT. 250/120 VOLTS. NEMA 14-20R FOR 20A BRANCH CIRCUIT, NEMA 14-30R FOR 30A BRANCH CIRCUIT UNLESS INDICATED OTHERWISE, FLUSH MOUNT C.L.

UP 18" A.F.F. OR AS INDICATED. GROUNDING RECEPTACLE WITH BOX, PLATE & BRANCH CIRCUIT, 250/120 VOLTS, NEMA 14-50R UNLESS

INDICATED OTHERWISE, FLUSH MOUNT C.L. UP 18" A.F.F. OR AS INDICATED. FINAL EQUIPMENT CONNECTION WITH OUTLET BOX, PLATE & BRANCH CIRCUIT, EQUIPMENT AS INDICATED, 120

VOLTS, VERIFY CONNECTION LOCATION WITH EQUIPMENT PROVIDER, CIRCUIT DESIGNATION.

EQUIPMENT ELECTRICAL SERVICES SYMBOLS LEGEND

EQUIPMENT POWER CONNECTION MARK, SEE EQUIPMENT ELEC. SERVICE SCHEDULE FOR BRANCH CIRCUIT & CONNECTION REQUIREMENTS, LOCATION SHOWN IS APPROXIMATE & REPRESENTATIVE.

BRANCH CIRCUIT & POWER CONNECTION TO ELECTRIC MOTOR, PROVIDE & CONNECT THRU PROPER DISCONNECT SWITCH ADJACENT TO UNIT, LOCATION SHOWN IS APPROXIMATE. CIRCUIT DESIGNATION.

BRANCH CIRCUIT & POWER CONNECTION TO EXHAUST FAN, INSTALL & CONNECT THRU CONTROL DEVICE & INTEGRAL DISCONNECT SWITCH, LOCATION SHOWN IS APPROXIMATE, CIRCUIT DESIGNATION.

BRANCH CIRCUIT & POWER CONNECTION TO HEAT TAPE CONTROL DEVICE, GFI PROTECTED CIRCUIT, PROVIDE & CONNECT THRU 20A1P MMS ADJACENT TO UNIT FOR DISCONNECT SWITCH, LOCATION SHOWN IS APPROXIMATE, CIRCUIT DESIGNATION.

VARIABLE FREQUENCY DRIVE, FURNISHED UNDER DIVISION 22/23, INSTALLED & CONNECTED BY DIVISION 26 CONTRACTOR, VERIFY LOCATION & CONNECTED EQUIPMENT PRIOR TO ROUGH-IN.

ENERGY MANAGEMENT SYSTEM CONTROL PANEL, PROVIDED UNDER DIVISION 23, POWER CONNECTION BY

DIVISION 26 CONTRACTOR, VERIFY LOCATION PRIOR TO ROUGH-IN.

BRANCH CIRCUITS & DIRECT FINAL CONNECTIONS TO MODULAR AIR HANDLING UNIT LIGHTING, 120/277V, VERIFY CONNECTION LOCATION & REQUIREMENTS WITH EQUIPMENT PROVIDER PRIOR TO ROUGH-IN, CIRCUIT



S/W JOB NO: 222075

CONSTRUCTION DOCUMENTS



PHONE: (601) 362-3552 FAX: (601) 366-6418 CONSULTANTS: **ELECTRICAL ENGINEER** SCHULTZ & WYNNE, P.A.

4523 OFFICE PARK DR.

JACKSON, MS 39206

T: (601) 982-3313

PROJECT:


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PROJECT NUMBER:


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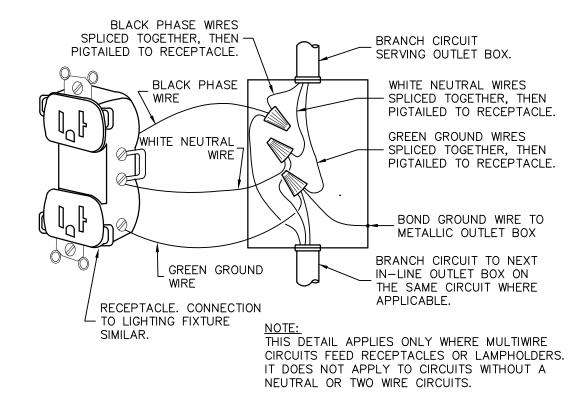
ELECTRICAL SYMBOLS LEGEND

SHEET NUMBER



# TYPICAL - MINI SPLIT SYSTEM ELECTRICAL CONNECTION DETAIL NO SCALE

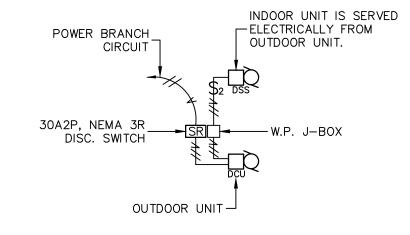

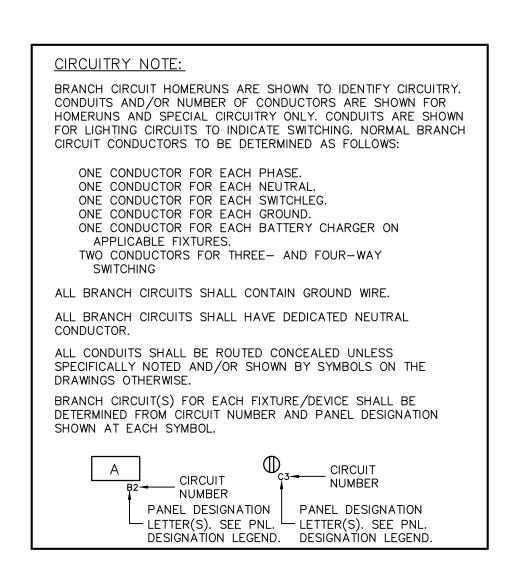

TYPICAL MULTIWIRE BRANCH CIRCUIT


# CONNECTION DIAGRAM

NOT TO SCALE

(	
<u> </u>	EQUIPMENT DESCR
+	H.P. VRF COND. UNIT
	H.P. VRF COND. UNIT
1	BRANCH CKT. CONTR
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	I.D. VRF BLOWER UNI
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	H.P. VRF COND. UNIT
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+	BRANCH CKT. CONTR
+	I.D. VRF BLOWER UNI
$\rightarrow$	I.D. VRF BLOWER UNI
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_	H.P. VRF COND. UNIT
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_	I.D. VRF BLOWER UNI
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+	I.D. VRF BLOWER UNI
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-	I.D. VRF BLOWER UNI
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$\rightarrow$	EXHAUST FAN
_	EXHAUST FAN
$\rightarrow$	EXHAUST FAN
+	EXHAUST FAN
	EXHAUST FAN
	EXHAUST FAN
EX	HAUST FAN
	E-911 BUILDING
1	MODULAR AIR HANDL
_	H.P. CONDENSING UN
_	AIR HANDLING UNIT
$\overline{}$	H.P. CONDENSING UN
+	AIR HANDLING UNIT
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+	COMPUTER RM. CONI
+	VAV TERMINAL UNIT
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-	VAV TERMINAL UNIT
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+	VAV TERMINAL UNIT
ì	MOTORIZED DAMPER
	AGRI-CENTER BUILDII
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	NDOOR BLOWER UNIA
	MINI-SPLIT SYS. COND.
	INDOOR BLOWER UNIT
١	MINI-SPLIT SYS. COND.
IN	IDOOR BLOWER UNIT
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EQUIPMENT ELECTRICAL SERVICE SCHEDULE NOTES:

- 1. PROVIDE & CONNECT NEW BRANCH CIRCUIT AS INDICATED IN EX'G ELECTRICAL PANELBOARD FOR REPLACEMENT EQUIPMENT. REPLACE SERVING C/B IN EX'G PANELBOARD WITH NEW C/B SIZED PER INDICATE MOCP.
- 2. PROVIDE & CONNECT NEW BRANCH CIRCUIT AS INDICATED IN EX'G ELECTRICAL PANELBOARD.

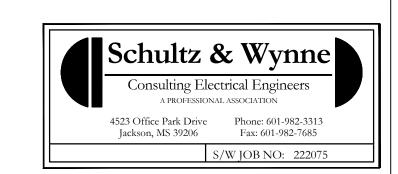

CONSTRUCTION DOCUMENTS

ENGINEERING
RESOURCE GROUP
350 EDGEWOOD TERRACE DRIVE

CONSULTANTS:

ELECTRICAL ENGINEER
SCHULTZ & WYNNE, P.A.
4523 OFFICE PARK DR.
JACKSON, MS 39206
T: (601) 982-3313

JACKSON, MS 39206 PHONE: (601) 362-3552 FAX: (601) 366-6418

PROJECT:

HVAC UPGRADES AUDERDALE COUNTY

#11869
#10/04/2022

SHEET TITLE:

ELECTRICAL SCHEDULES & DETAILS

SHEET NUMBER

F0.2

**ENGINEERING** 

RESOURCE GROUP
350 EDGEWOOD TERRACE DRIVE


JACKSON, MS 39206 PHONE: (601) 362-3552 FAX: (601) 366-6418


CONSULTANTS:

ELECTRICAL ENGINEER SCHULTZ & WYNNE, P.A.

4523 OFFICE PARK DR. JACKSON, MS 39206 T: (601) 982-3313

PROJECT:

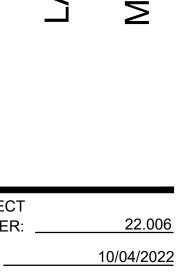

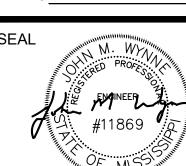


SHEET TITLE:

HUMAN SERVICES BLDG. ELECTRICAL 1ST FLOOR PLAN

SHEET NUMBER

E1.1

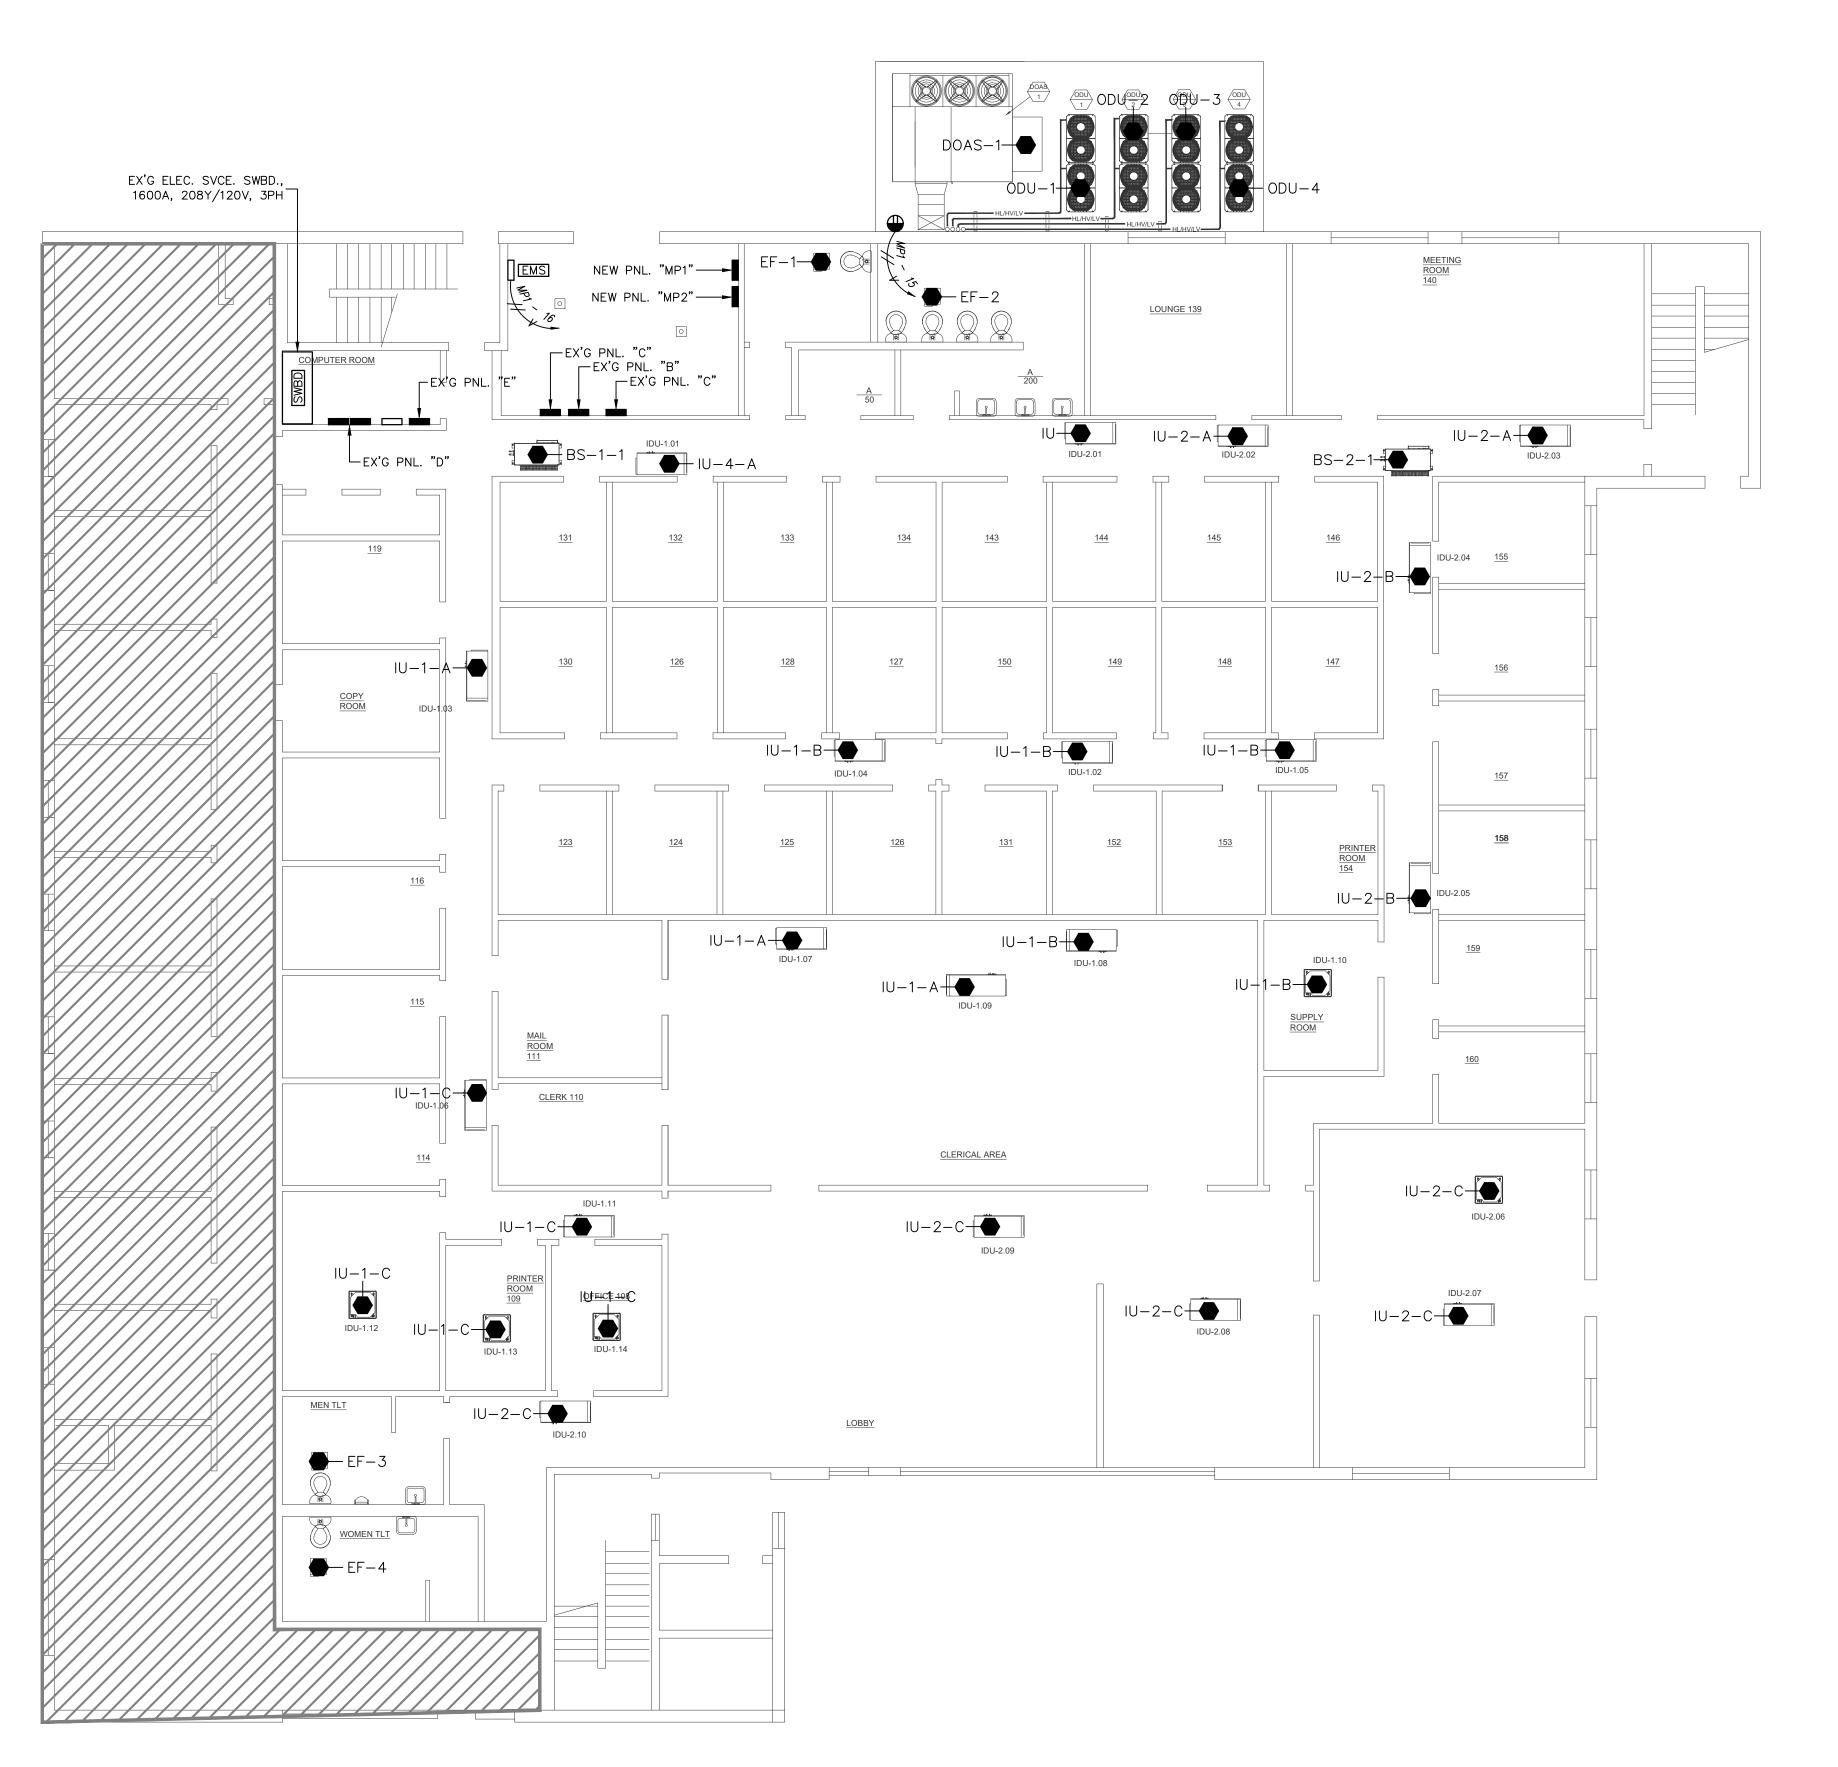







CONSTRUCTION DOCUMENTS

**ENGINEERING** 


RESOURCE GROUP 350 EDGEWOOD TERRACE DRIVE


JACKSON, MS 39206 PHONE: (601) 362-3552 FAX: (601) 366-6418

CONSULTANTS:

PROJECT:

ELECTRICAL ENGINEER SCHULTZ & WYNNE, P.A. 4523 OFFICE PARK DR. JACKSON, MS 39206 T: (601) 982-3313

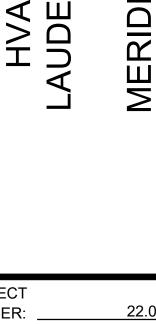

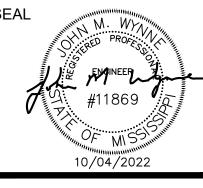


SHEET TITLE:

**HUMAN SERVICES** BLDG. ELECTRICAL 2ND FLOOR PLAN

SHEET NUMBER

E1.2

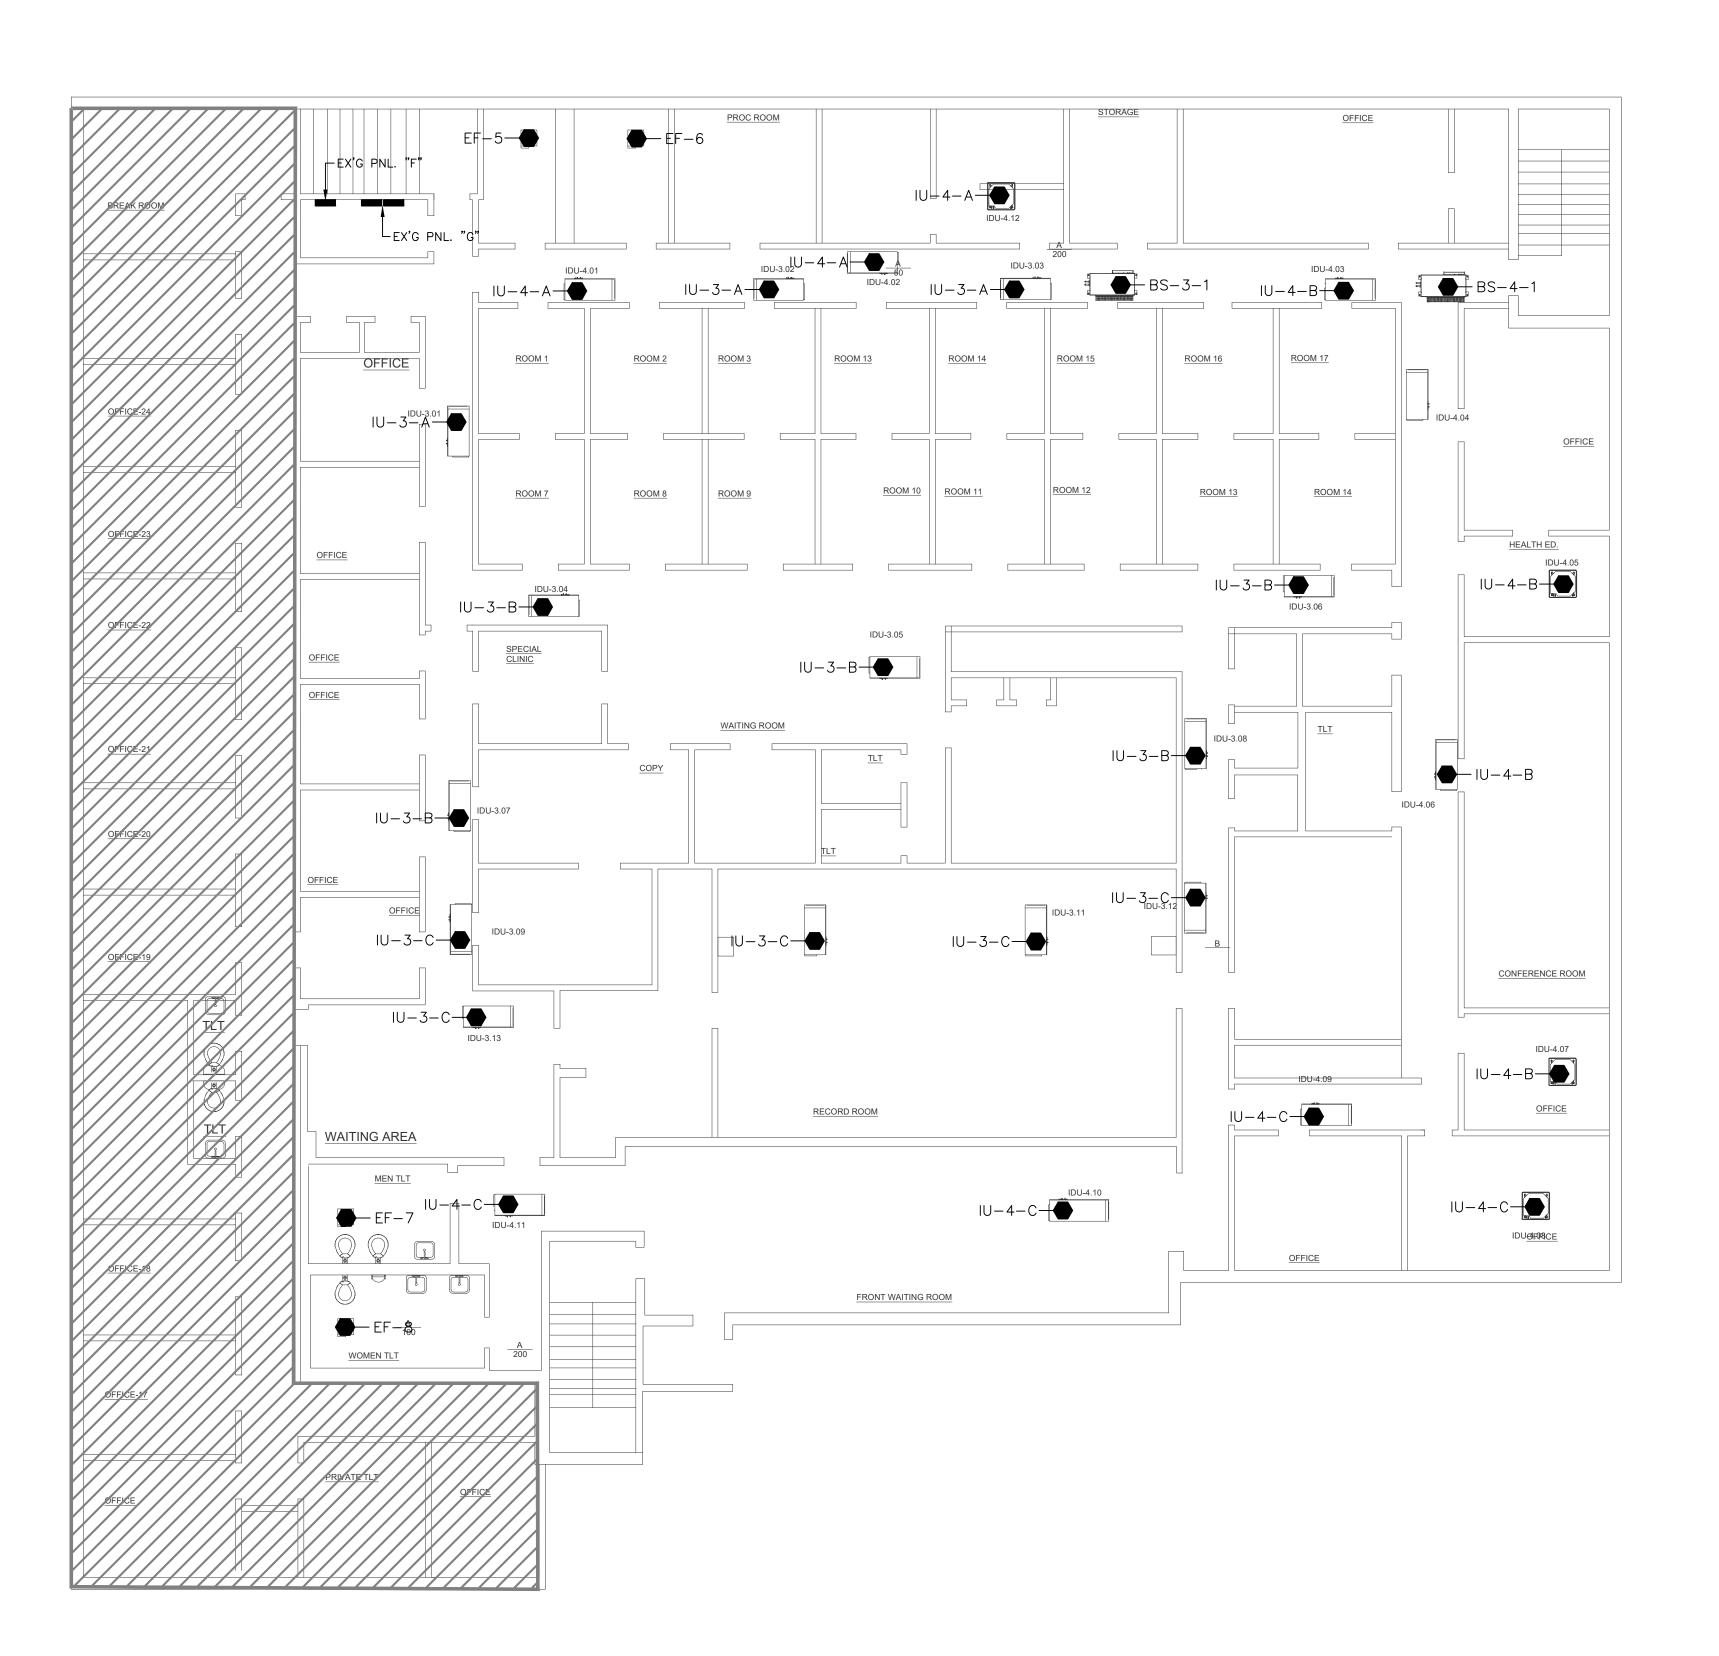






						PANE	EL"	'MP1"						
	VOLTS: 208Y/120 MAIN: 400A NEUTRAL: 100%		PHASE: WIRE: FROM:	4		RVICE	SWI	TCHBOA	\RD				MOUNTING: SURFACE K.A.I.C: 35 I BREAKER: NONE	
KT.			KVA		BRE	AKER		BRE	AKER		KVA			CK.
10.	LOAD DESCRIPTION	PH. A	PH. B	PH. C	AMPS	POLES	PH	1 land to this cont		PH. A	PH. B.	PH. C	LOAD DESCRIPTION	NC
	H.P. VRF COND. UNIT	4.40			70	3	Α	3	70	4.40			H.P. VRF COND. UNIT	
	ODU-1 (CIRCUIT #1)	7.70	4.40		70	-	В		10	7.70	4.40		ODU-2 (CIRCUIT #1)	
	OBO-1 (OIROOTI #1)	1	7.70	4.40			C				7.70	4.40	ODO-2 (OIROOH #1)	$\vdash$
3	H.P. VRF COND. UNIT	3.38		7.70	50	3	A	3	50	3.38		7.70	H.P. VRF COND. UNIT	
	ODU-1 (CIRCUIT #2)	3.30	3.38		- 50		В	-	- 50	3.30	3.38		ODU-2 (CIRCUIT #2)	
	OBO 1 (OIROOTI 112)	<del> </del>	0.00	3.38			С				0.00	3.38	0B0 2 (0ll(0011 ll2)	$\vdash$
5	DEDICATED OUTSIDE	8.61		0.00	110	3	A	3	70			0.00	SPARE	(
	AIR UNIT DOAS-1	0.01	8.61		110		В		10				OTTAL	H
	ALL CHIL BOAG 1	-	0.01	8.61			С							
7	VRF BLOWER UNITS	1.00		0.01	15	2	A	2	15	1.00			VRF BLOWER UNITS	(
	BS-1-1; IU-1-A	1.00	1.00		13		В		13	1.00	1.00		BS-2-1; IU-2-A	_
	VRF BLOWER UNITS	-	1.00	4.00	15	2		2	15		1.00	4.00	VRF BLOWER UNITS	
9	E F F F F F F F F F F F F F F F F F F F	4.00		1.00	15		C		15	4.00		1.00		_
4	IU-1-B	1.00	4.00		45	0	A		45	1.00	4.00		IU-2-B	
	VRF BLOWER UNITS		1.00	4.00	15	2	В	2	15		1.00	4.00	VRF BLOWER UNITS	_
	IU-1-C		<u> </u>	1.00	45	_	C		45			1.00	IU-2-C	_
13	SPARE				15	2	A	2	15				SPARE	1
1.	O D DECERTACIE	ļ		4.00	00	4	В	4	00			4.00	EMO CONTROL DANIEL	_
	O.D. RECEPTACLE	0.50		1.00	20	1	C	1	20	0.50		1.00	EMS CONTROL PANEL	1
	EXH. FANS EF-1, EF-2	0.50			20	1	A	1	20	0.50			EXH. FANS EF-3, EF-4	-
	SPARE	<u> </u>			20	1	В	1	20				SPARE	_
21	SPARE				20	1	С	1	20				SPARE	2
	REMARKS:													
						PANE	EL"	'MP1"						
	TOTAL CONNECTED LO	AD - KV	A:							EMAND -			86.5 240.4	
	PHASE A:			29.2										
	PHASE B:			28.2					SPARE	CAPAC	TY - %:		15%	
	PHASE C:			30.2										
TOTAL CONNECTED LOAD: 87.5							TOTAL LOAD - KVA: 99.5 TOTAL LOAD - AMPS: 276.5							


DLTS: 208Y/120 AIN: 400A EUTRAL: 100%					PANE	L"	MP2"						
	FED	PHASE: WIRE: FROM:	4		RVICE	SWI	ГСНВОА	RD				MOUNTING: SURFACE K.A.I.C: 35 I BREAKER: NONE	
		KVA		BRE	AKER		BRE A	KER		KVA			Cł
OAD DESCRIPTION	PH. A	PH. B	PH. C	AMPS	POLES	PH	POLES	AMPS	PH. A	PH. B.	PH. C	LOAD DESCRIPTION	N
P. VRF COND. UNIT	4.40			70	3	Α	3	50	3.38			H.P. VRF COND. UNIT	Ť
DU-3 (CIRCUIT #1)		4.40				В				3.38		ODU-4 (CIRCUIT #1)	
,			4.40			С					3.38	, ,	T
P. VRF COND. UNIT	4.40			70	3	Α	3	50	3.38			H.P. VRF COND. UNIT	T
DU-3 (CIRCUIT #2)		4.40				В				3.38		ODU-4 (CIRCUIT #2)	
			4.40			C					3.38		
PARE				70	3	Α	3	50				SPARE	
						В							
						С							
RF BLOWER UNITS	1.00			15	2	Α	2	15	1.00			VRF BLOWER UNITS	
S-3-1; IU-3-A		1.00				В				1.00		BS-4-1; IU-4-A	
RF BLOWER UNITS			1.00	15	2	С	2	15			1.00	VRF BLOWER UNITS	
-3-B	1.00					Α			1.00			IU-4-B	_
RF BLOWER UNITS		1.00		15	2	В	2	15		1.00		VRF BLOWER UNITS	,
-3-C			1.00			С					1.00	IU-4-C	
PARE				15	2	Α	2	15				SPARE	
						В							T
(H. FANS EF-5, EF-6			0.50	20	1	С	1	20			0.50	EXH. FANS EF-7, EF-8	
PARE				20	1	Α	1	20				SPARE	19
PARE				20	1	В	1	20				SPARE	1
PARE				20	1	C	1	20				SPARE	1
	PU-3 (CIRCUIT #1) P. VRF COND. UNIT PU-3 (CIRCUIT #2)  ARE  F BLOWER UNITS -3-1; IU-3-A F BLOWER UNITS 3-B F BLOWER UNITS 3-C ARE H. FANS EF-5, EF-6 ARE ARE	ARE  F BLOWER UNITS 3-B, IU-3-A F BLOWER UNITS 3-B, IL-3-A F BLOWER UNITS 3-B, IL-3-A F BLOWER UNITS 3-B, IL-3-A F BLOWER UNITS 3-C ARE H. FANS EF-5, EF-6 ARE ARE	## A.40  P. VRF COND. UNIT  P. VRF COND. UNIT  ## A.40  ## BLOWER UNITS  ## A.40  ## BLOWER UNITS  ## A.40  ## BLOWER UNITS  ## A.40  ## A.40	## PLOWER UNITS   1.00	## PU-3 (CIRCUIT #1)  ## PU-3 (CIRCUIT #1)  ## PU-3 (CIRCUIT #2)  ## PU-3 (CIRCUIT #1)  ## PU-4 (CIRCUIT #1)	ARE  10.04.3 (CIRCUIT #1)  4.40  4.40  70  3  4.40  4.40  4.40  4.40  ARE  70  3  4.40  4.40  4.40  70  3  4.40  4.40  70  3  4.40  4.40  70  3  4.40  4.40  70  3  4.40  70  3  4.40  70  3  4.40  70  3  4.40  70  15  2  3-3-1; IU-3-A  F BLOWER UNITS  1.00  F BLOWER UNITS  3-B  1.00  F BLOWER UNITS  1.00  15  2  4.40	B   B   C   C   C   C   C   C   C   C	DU-3 (CIRCUIT #1)	DU-3 (CIRCUIT #1)	ALLONGO CONTROL (CIRCUIT #1)  4.40  4.40  C. VRF COND. UNIT  4.40  70  3 A 3  50  3.38  DU-3 (CIRCUIT #2)  4.40  ARE  70  3 A 3  50  3.38  C  4.40  C  ARE  70  3 A 3  50  3.38  C  ARE  70  3 A 3  50  A 4  A 5  B  C  C  ARE  A 2  15  1.00  B 5  C 2  A 2  15  1.00  A 3-1; IU-3-A  B 6  B 7  A 1.00  F BLOWER UNITS  3-B  1.00  F BLOWER UNITS  1.00  15  2 C 2  15  3-B  3-C  ARE  1.00  15  2 B 2  15  3-C  ARE  1.00  ARE  1.00  15  2 B 2  15  A 2  15  ARE  A 1  100  ARE  100  ARE  110  ARE  110	3.38   3.38	3.38   3.38	Nu-3 (CIRCUIT #1)

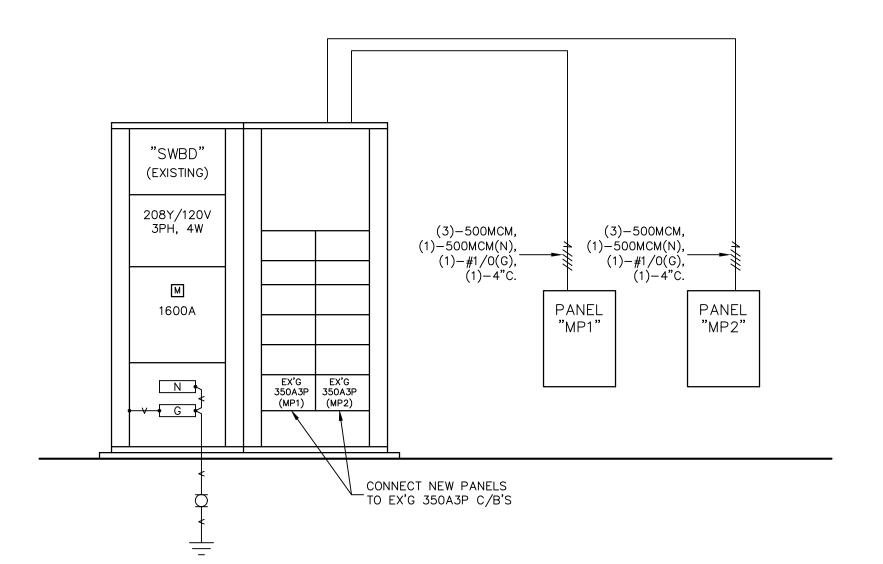


HUMAN SERVICES BUILDING
ELECTRICAL DISTRIBUTION SYSTEM

SCHEMATIC POWER RISER DIAGRAM — NEW WORK

No scale

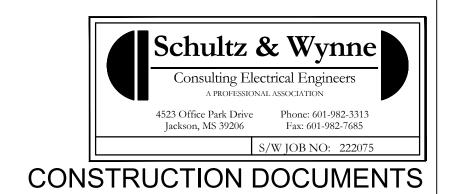

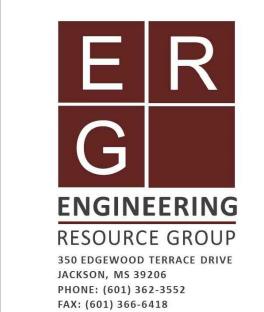

CONSULTANTS:

ELECTRICAL ENGINEER
SCHULTZ & WYNNE, P.A.
4523 OFFICE PARK DR.
JACKSON, MS 39206
T: (601) 982-3313

PROJECT:

HVAC UPGRADES LAUDERDALE COUNTY

PROJECT NUMBER:	22.006
DATE:	10/04/2022
DRAWN BY:	JMW
CHECKED BY:	JMW
REV: 0	


#11869 #11869 #10/04/2022

SHEET TITLE:

HUMAN SERVICES BLDG. ELECTRICAL SCHEDULES & DETAILS

SHEET NUMBER


E1.3

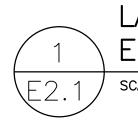

LAUDERDALE COUNTY EMERGENCY SERVICES BLDG. ELECTRICAL 1ST FLOOR PLAN — NEW WORK

SCALE: 1/8" = 1'-0"



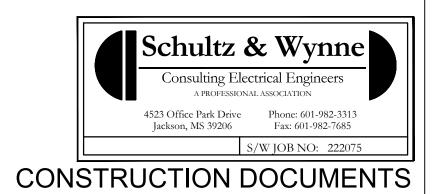



CONSULTANTS:

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PROJECT:

HVAC UPGRADES LAUDERDALE COUNTY

PROJECT
NUMBER: 22.006

DATE: 10/04/2022

DRAWN BY: JMW

CHECKED BY: JMW

REV: 0

CHECKED BY: JMW

REV: 0

1

2

3

#11869
#10/04/2022

SHEET TITLE: EMERO

EMERGENCY SERVICES BLDG. ELECTRICAL 1ST FLOOR PLAN


SHEET NUMBER

E2.1

LAUDERDALE COUNTY EMERGENCY SERVICES BLDG. ELECTRICAL 2ND FLOOR PLAN — NEW WORK

SCALE: 1/8" = 1'-0"



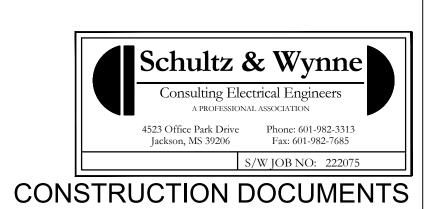



CONSULTANTS:

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JACKSON, MS 39206 T: (601) 982-3313

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PROJECT:

HVAC UPGRADES LAUDERDALE COUNTY

PROJECT
NUMBER: 22.006

DATE: 10/04/2022

DRAWN BY: JMW

CHECKED BY: JMW

REV: 0

#11869 #10/04/2022


SHEET TITLE:

EMERGENCY
SERVICES BLDG.
ELECTRICAL
2ND FLOOR PLAN

SHEET NUMBER

E2.2

SCALE: 1/8" = 1'-0"

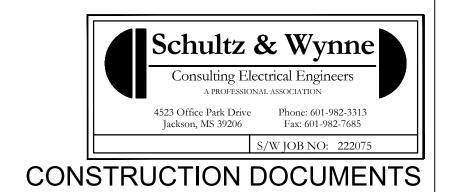



CONSULTANTS:

ELECTRICAL ENGINEER
SCHULTZ & WYNNE, P.A.


4523 OFFICE PARK DR. JACKSON, MS 39206 T: (601) 982-3313

PHONE: (601) 362-3552

PROJECT:

HVAC UPGRADES LAUDERDALE COUNTY

PROJECT	
NUMBER:	22.0
DATE:	10/04/20
DRAWN BY:	JM
CHECKED BY:	JM

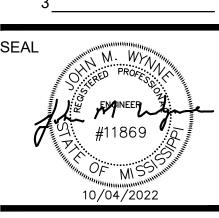


SHEET TITLE:

AGRI-CENTER BLDG. ELECTRICAL UPPER LEVEL PLAN

SHEET NUMBER

E3.1


						PANE	L "	RBA"						
	VOLTS: 208Y/120	I	PHASE:										MOUNTING: SURFACE	
	MAIN: 125A		WIRE:										K.A.I.C: 10	
	NEUTRAL: 100%	FED	FROM:	EXG P	ANEL "R	RB"						MAIN	BREAKER: NONE	
CKT.			KVA		BREA	AKER		BRE	AKER		KVA			CK
NO.	LOAD DESCRIPTION	PH. A	PH. B	PH. C	AMPS	POLES	PH	POLES	AMPS	PH. A	PH. B.	PH. C	LOAD DESCRIPTION	NC
1	MINI-SPLIT SYSTEM	0.83			20	2	Α	2	20	0.83			MINI-SPLIT SYSTEM	1 2
	CU-1/DSS-1		0.83				В				0.83		CU-2/DSS-2	:
3	MINI-SPLIT SYSTEM			0.83	15	2	С	2	15			0.83	MINI-SPLIT SYSTEM	4
	CU-3/DSS-3	0.83					Α			0.83			CU-4/DSS-4	-
5	MINI-SPLIT SYSTEM		0.83		15	2	В	2	20				SPARE	6
	CU-5/DSS-5			0.83			C							
	DEHUMIDIFIER DH-3	0.60			20	1	Α	1	20	0.50			EXH. FAN EF-2	2 8
9	DEHUMIDIFIER DH-4		0.60		20	1	В	1	20		0.50		EXH. FAN EF-3	10
11	DEHUMIDIFIER DH-5			0.60	20	1	С	1	20			0.50	EXH. FANS EF-4,-5,-6	1.
13	O.D. RECEPT.	1.00			20	1	Α	1					SPACE	14
15	SPARE				20	1	В	1					SPACE	16
17	SPARE				20	1	С	1					SPACE	18
19	SPACE					1	Α	1					SPACE	20
21	SPACE					1	В	1					SPACE	22
23	SPACE					1	С	1					SPACE	24
	REMARKS: PROVIDE & PANEL "RE					(3)-#6,	(1)-#				PANEL'	'RBA".		
						FAINE	_	NDA						
	TOTAL CONNECTED LC	AD - KV	'A:							EMAND -		•	12.1 33.6	
	PHASE A:			5.4	1			10	TAL DE	WAND -	AIVIPS.		33.0	
	PHASE B:			3.6					SPARE	CAPAC	ITY - %:		25%	
	PHASE C:			3.6	]							!		
									TO	L LOAD	1/1/14		15.1	

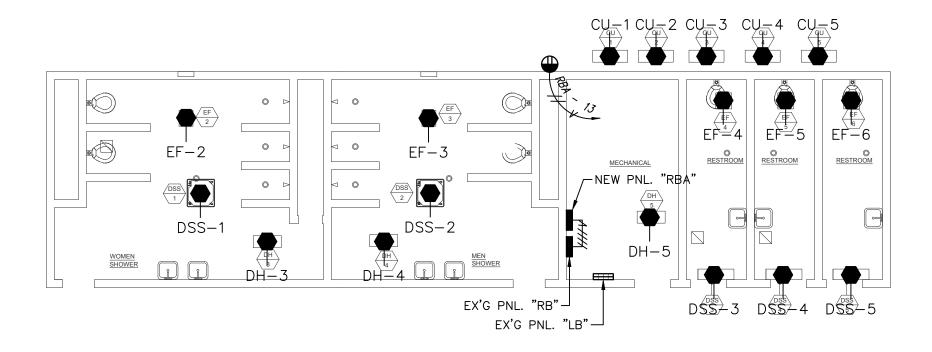


LAUDERDALE COUNTY AGRI—CENTER BLDG.

1 ELECTRICAL LOWER LEVEL PLAN — NEW WORK

E3.2 SCALE: 1/8" = 1'-0"

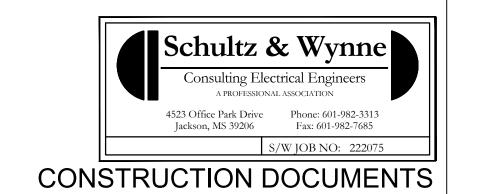

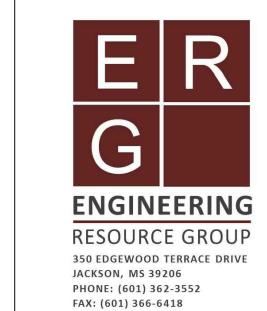

CONSULTANTS:

ELECTRICAL ENGINEER
SCHULTZ & WYNNE, P.A.
4523 OFFICE PARK DR.
JACKSON, MS 39206
T: (601) 982-3313

PROJECT:

HVAC UPGRADES LAUDERDALE COUNTY

PROJECT	
NUMBER:	22.006
DATE:	10/04/202
DRAWN BY:	JMV
CHECKED BY:	JMV
REV: 0	
1	
2	

#11869
#MSOLUTION

#10/04/2022

SHEET TITLE:

AGRI-CENTER BLDG. ELECTRICAL LOWER LEVEL PLAN

SHEET NUMBER

E3.2



# PRE-BID CONFERENCE MINUTES

DATE	TIME
JANUARY 19, 2023	10:00 AM

### **PROJECT INFORMATION**

PROJECT NAME & NUMBER	HVAC Upgrades – Lauderdale County
PROJECT LOCATION	Meridian, MS
ERG PN	22.006

### **PROFESSIONAL**

ENGINEERING RESOURCE GROUP, INC.				
NAME	TITLE	PHONE	EMAIL	
Chad Moore	Project Engineer	(601) 362-3552 (O) (601) 940-9704 (M)	cmoore@ergms.com	

### **OWNER**

Lauderdale Cou	nty, MS		
NAME	TITLE	PHONE	EMAIL
Chris Lafferty	County Administrator	(601) 482-9751	clafferty@lauderdalecounty.org
Reza Bazyari	Facilities Director	(601) 479-4137	rbazyari@lauderdalecounty.org

### **KEY BIDDING DATES**

DESCRIPTION	DATE – TIME
PRE-BID CONFERNCE	1/19/2023 – 10:00 am
ALL QUESTIONS TO ERG	2/2/2023 at 5:00 pm
LAST ADDENDUM	2/3/2023 at 5:00 pm
BID DATE	2/8/2023 at 2:00 pm

PROJECT DURATION:	365 Consecutive Calendar Days
LIQUIDATED DAMAGES	\$250.00 per calendar day



- A. Reviewed Section 002113 Instructions to Bidders.
  - 1. Encouraged bidders to review this section.
  - 2. Submit bids in sealed opaque envelope.
  - 3. Include all required information with bid. Documents shall include but not limited to the following:
    - a. Bid Security.
    - b. Power of Attorney.
- B. Reviewed Section 004113 Bid Proposal Form.
  - 1. Complete all blanks. If blank is Not Applicable include N/A.
  - 2. Time of Completion: 365 consecutive calendar days.
  - 3. Liquidated Damages: \$250 for each calendar day.
  - 4. Acknowledge all addenda. It is the contractor's responsibility to confirm all addenda.

### C. Base Bid:

- 1. Human Services Building: HVAC system replacement.
- D. Add Alternate No. 1: (Changed via Addendum 1)
  - 1. Emergency Services (E-911) Building: HVAC system replacement.
- E. Add Alternate No. 2: (Changed via Addendum 1)
  - 2. Agri-Center: New HVAC systems.
- F. Human Services:
  - 1. Work performed on 1 floor at a time. Initial floor shall be completed prior to moving to the second floor.
  - 2. Complete HVAC system replacement.
  - 3. Ceiling demolition.
  - 4. New HVAC and control systems.



- 5. Testing, Adjusting, and Balancing of HVAC systems.
- 6. Replace ceilings (salvage lights and all other ceiling mounted devices).
- 7. Patching, painting, repairing; building to be restored to condition prior to work beginning.
- 8. Electrical system demolition and service to new equipment.

### G. Emergency Services:

- 1. Careful coordination with Owner is required while performing work in this building.
- Complete HVAC system replacement.
- 3. Ceiling demolition.
- 4. New HVAC and control systems.
- 5. Testing, Adjusting, and Balancing of HVAC systems.
- 6. Replace ceilings (salvage lights and all other ceiling mounted devices).
- 7. Patching, painting, repairing; building to be restored to condition prior to work beginning.
- 8. Electrical system demolition and service to new equipment.

### H. Agri-Center:

- 1. Work performed around events at the facility.
- 2. New HVAC systems in the restrooms.
- 3. Ceiling demolition.
- 4. Testing, Adjusting, and Balancing of HVAC systems.
- 5. Replace ceilings (salvage lights and all other ceiling mounted devices).
- 6. Patching, painting, repairing; building to be restored to condition prior to work beginning.
- 7. Electrical system demolition and service to new equipment.

ERG urged bidders to review plans and project manual carefully. Contact ERG with questions or concerns.

Attendees were encouraged to walk the project site to familiarize themselves with the existing site conditions and contact ERG with any questions, comments, or concerns.

Pre-bid conference adjourned at 11:00 am.



This is the majority of the items discussed at the pre-bid conference as noted by ERG. Anyone wishing to suggest additions or modifications to these minutes is to do so in writing to ERG within three (3) calendar days of their receipt of these minutes.

Thanks and respectfully submitted,

Chad E. Moore, P.E.

Cll E. Mar

Principal

Email Copy: All Attendees