PROJECT SITE: LAUDERDALE COUNTY ANIMAL SHELTER 6100 ROCKY LANE

MARION, MS 39342 PRIME PROFESSIONAL AND MECHANICAL ENGINEER: **ENGINEERING RESOURCE GROUP**

350 EDGEWOOD TERRACE DRIVE JACKSON, MS 39206 T: (601) 362-3552

F: (601) 366-6418

ELECTRICAL ENGINEER SCHULTZ & WYNNE, P.A. 4523 OFFICE PARK DR. JACKSON, MS 39206 T: (601) 982-3313

REGULATORY STANDARDS

APPLICABLE CODES AND STANDARDS INCLUDE BUT ARE NOT LIMITED TO THE FOLLOWING:

2018 - INTERNATIONAL BUILDING CODE 2018 - INTERNATIONAL MECHANICAL CODE 2018 - INTERNATIONAL FUEL GAS CODE ASHRAE STANDARD 90.1-2010

PROJECT SUMMARY

LAUDERDALE COUNTY ANIMAL SHELTER PROJECT INCLUDES, BUT IS NOT LIMITED TO:

- 1. REMOVE EXISTING (2) LOW PRESSURE AIR HANDING UNITS, CONDENSING UNITS, ALL RELATED DUCTWORK, CONTROLS, HANGERS, SUPPORTS, ETC.
- REMOVE EXISTING (2) EXHAUST FANS SYSTEM AND ALL RELATED DUCTWORK.
- INSTALL NEW DOAS UNIT, RELATED DUCTWORK, AND CONTROLS.
- TESTING, ADJUSTING, AND BALANCING OF ALL NEW AND EXISTING HVAC SYSTEMS AND EQUIPMENT. TAB AGENCY TO ADJUST AIRFLOW SUCH THAT THE BUILDING HAS A NET POSITIVE PRESSURE RELATIVE TO OUTDOORS UNDER ALL OPERATING CONDITIONS.
- 5. PROVIDE NATURAL GAS LINE TO NEW DOAS UNIT. NEW GAS LINE SHALL BE SIZED AND INSTALLED PER THE 2018 INTERNATIONAL FUEL GAS CODE. MODIFY EXISTING NATURAL GAS SERVICE IN CONJUNCTION WITH THE SERVING NATURAL GAS UTILITY COMPANY.
- 6. PROVIDE CONDENSATE LINE FROM DOAS TO NEAREST STORM OR SANITARY SEWER LINE BELOW
- PROVIDE ELECTRICAL SERVICE TO NEW DOAS UNIT. MODIFY EXISTING ELECTRICAL AS REQUIRED. DEMO EXISTING ELECTRICAL TO EXISTING HVAC EQUIPMENT REMOVED UNDER THIS CONTRACT.
- REMOVE EXISTING CEILINGS, CEILING GRID, AND CEILING TILES AS REQUIRED TO PERFORM WORK. 9. RE-INSTALL REMOVED CEILINGS, CEILING GRID, AND CEILING TILES. PATCH, PAINT REPAIR, REPLACE DAMAGED CEILINGS, CEILING GRID, AND CEILING TILES. NEW CEILING, CEILING GRID, AND CEILING TILES SHALL MATCH EXISTING.
- 10. CUTTING, PATCHING, REPAIRING, PAINTING, ETC. DAMAGED SURFACES/FINISHES.

SPECIAL PROJECT NOTES

1. ANY UTILITY OUTAGES SHALL BE COORDINATED WITH THE OWNER AND PROFESSIONAL AND SHALL BE PERFORMED DURING PERIODS CONVENIENT FOR THE OWNER. OUTAGES WILL LIKELY BE REQUIRED TO BE PERFORMED AT NIGHT, ON WEEKENDS, HOLIDAYS, ETC. (PERIODS OF LIGHT OR NO CAMPUS

GENERAL NOTES

- EACH CONTRACTOR, SUPPLIER AND/OR MANUFACTURER SHALL REFER TO ALL DOCUMENTS PERTAINING TO THIS PROJECT AND COORDINATE ACCORDINGLY SO AS TO ENSURE ADEQUACY OF FIT, COMPLIANCE WITH SPECIFICATIONS, PROPER ELECTRICAL SERVICE, AND AVOID CONFLICT WITH ANY OTHER BUILDING SYSTEMS. VERIFY SAME WITH SHOP DRAWINGS.
- ALL OFFSETS, TURNS, FITTINGS, TRIM, DETAIL, ETC., MAY NOT BE INDICATED, BUT SHALL BE PROVIDED AS REQUIRED. ADDITIONAL ALLOWANCES SHALL BE INCLUDED FOR SAME AT EACH PROPOSERS' DISCRETION.
- OBSERVE ALL APPLICABLE CODES. RULES AND REGULATIONS (CITY, COUNTY, LOCAL, STATE, FEDERAL, MUNICIPALITY, UTILITY COMPANY, OSHA, ETC.).
- ALL SYSTEMS, EQUIPMENT, AND MATERIALS ARE TO BE INSTALLED IN A NEAT AN WORKMANLIKE MANNER. WORK NOT DONE SO SHALL BE REMOVED AND REINSTALLED SATISFACTORILY.
- WHERE MOUNTING HEIGHTS ARE NOT INDICATED OR ARE IN CONFLICT WITH ANY OTHER BUILDING SYSTEM, CONTACT THE ENGINEER BEFORE INSTALLATION. REFER ALSO TO ARCHITECTURAL WALL INTERIOR AND EXTERIOR WALL ELEVATIONS. CEILING HEIGHTS AND OTHER DETAILS OF THESE DOCUMENTS. REFERENCE SPECIFICATION 230010 "MECHANICAL GENERAL PROVISIONS" FOR COORDINATION DRAWING REQUIREMENTS.
- DO NOT SCALE DRAWINGS, PRINTING DISTORTS SCALE. WORK SHALL BE LAID OUT FROM DIMENSIONED DRAWINGS, OR DIMENSIONS SUPPLIED TO THE CONTRACTOR.
- THE CONTRACTOR SHALL BE RESPONSIBLE FOR ALL CUTTING AND PATCHING REQUIRED FOR THEIR WORK, ALL CUTTING AND PATCHING SHALL MATCH ADJACENT SURFACES.
- THESE DRAWINGS ARE ACCURATE TO THE BEST OF OUR KNOWLEDGE. HOWEVER LOCATIONS, DEPTHS. ELEVATIONS, AND SIZES WERE TAKEN FROM DIFFERENT SOURCES AND ARE SUBJECT TO DEVIATION. THE CONTRACTOR SHALL ASSUME SOME DEVIATIONS AND INCLUDE OFFSETS, ADDITIONAL PIPING, ETC. AT THE
- ADVISE THE ENGINEER OF ANY CONFLICTS, ERRORS, OMISSIONS, ETC. AT LEAST TEN DAYS PRIOR TO BID DATE, TO ALLOW CLARIFICATION BY WRITTEN ADDENDUM.
- 10. DEVIATION FROM SPECIFICATIONS OR PLANS REQUIRES PRIOR WRITTEN APPROVAL FROM THE ENGINEER AND MUST BE SUBMITTED IN WRITING NO LATER THAN TEN DAYS PRIOR TO THE BID DATE.
- 11. THE PURPOSE AND INTENT OF THE DOCUMENTS PERTAINING TO THIS PROJECT IS TO PROVIDE A COMPLETE. FUNCTIONAL, AND SAFE FACILITY, ANYTHING LESS SHALL BE UNACCEPTABLE.
- 12. ALL VIBRATING, OSCILLATING, NOISE PRODUCING OR ROTATING EQUIPMENT SHALL BE ISOLATED FROM SURROUNDING SYSTEMS IN AN APPROVED MANNER. NOISY, VIBRATING, OR STRUCTURALLY DAMAGING INSTALLATIONS SHALL BE SATISFACTORILY REPLACED OR REPAIRED AT THE INSTALLING CONTRACTOR'S EXPENSE. THE FINAL DECISION ON THE SUITABILITY OF A PARTICULAR INSTALLATION SHALL BE THAT OF THE ARCHITECT.
- . INSTALL EQUIPMENT, MATERIALS, ETC. IN STRICT ACCORDANCE WITH MANUFACTURER'S RECOMMENDATIONS AND DIRECTIONS. IF IN CONFLICT WITH THE DESIGN INDICATED IN CONTRACT DOCUMENTS, ADVISE THE ARCHITECT PRIOR TO INSTALLATION FOR CLARIFICATION.
- 14. ALL SUPPORTS FOR EQUIPMENT, DEVICES, OR FIXTURES SHALL BE UNIQUE FROM THE BUILDING STRUCTURE DO NOT SUPPORT FROM OTHER TRADES, EQUIPMENT OR SUPPORTS WITHOUT WRITTEN PERMISSION FROM THE ARCHITECT AND CONSENT OF THE OTHER TRADE, IN WRITING.
- DEVIATIONS IN SIZE, CAPACITIES, FIT, FINISH, ETC. FOR EQUIPMENT FROM THAT SPECIFIED SHALL BE THE RESPONSIBILITY OF THE PURCHASER OF THAT EQUIPMENT. ANY PROVISIONS REQUIRED TO ACCOMMODATE A DEVIATION, WHETHER APPROVED BY THE ARCHITECT OR NOT, SHALL BE THE RESPONSIBILITY OF THE PURCHASER.
- 16. THE GENERAL CONTRACTOR FOR THIS CONSTRUCTION IS RESPONSIBLE FOR THE COORDINATION, APPEARANCE, SCHEDULING, AND TIMELINESS OF THE WORK OF ALL TRADES, CONTRACTORS, SUPPLIERS,
- THE GENERAL CONTRACTOR, MECHANICAL CONTRACTOR, AND ALL OTHER CONTRACTORS SHALL ENSURE PROPER COORDINATION BETWEEN ALL TRADES SUCH THAT CONDUITS, PIPING, DUCTWORK, ETC. DO NOT BLOCK ACCESS TO VALVES, EQUIPMENT, DUCT ACCESS DOORS, ETC. ITEMS THAT HAVE BEEN INSTALLED WHERE ACCESS IS COMPROMISED SHALL BE RELOCATED AT THE CONTRACTOR'S EXPENSE.
- 18. THE CONTRACTOR SHALL INCLUDE IN THEIR BID ALL COSTS ASSOCIATED WITH DRAINING, FLUSHING, AND FILLING PIPING SYSTEMS AS REQUIRED TO INSTALL THEIR NEW WORK.
- 9. PRIOR TO ORDERING ANY MATERIALS OR ROUGH-IN OF ANY KIND, THE MECHANICAL CONTRACTOR SHALL BE RESPONSIBLE FOR FINAL COORDINATION OF ALL ELECTRICAL REQUIREMENTS (I.E., VOLTAGE, PHASE, CIRCUIT BREAKER, WIRING SIZE, ETC.) WITH THE ELECTRICAL CONTRACTOR. THERE WILL BE NO CHANGE IN THE CONTRACT AMOUNT FOR ANY DISCREPANCIES. MECHANICAL CONTRACTOR SHALL COORDINATE WITH ALL OTHER CONTRACTORS, VENDORS, AND SUPPLIERS AND SHALL INSURE COMPLETE, 100% FUNCTIONAL, TESTED, INSPECTED, AND APPROVED SYSTEMS. CLAIMS FOR ADDITIONAL COST OR CHANGE ORDERS WILL IMMEDIATELY BE REJECTED.
- 20. EQUIPMENT BRACING WILL BE INCLUDED FOR ALL OVERHEAD UTILITIES AND OTHER EQUIPMENT WEIGHING 31 POUNDS OR MORE (EXCLUDING DISTRIBUTED SYSTEMS SUCH AS PIPING, ETC.). BRACING SHALL BE ACCOMPLISHED BY EITHER RIGID OR FLEXIBLE SYSTEMS. ALL EQUIPMENT MOUNTINGS SHALL BE DESIGNED TO RESIST FORCES OF 0.5 TIMES THE EQUIPMENT WEIGHT IN ANY DIRECTION AND 1.5 TIMES THE EQUIPMENT WEIGHT IN THE DOWNWARD DIRECTION, ALL BRACING SHALL BE CONTRACTOR DESIGNED.

DRAWING INDEX

DESCRIPTION

TITLE SHEET

HVAC LEGEND AND ABBREVIATIONS

FIRST FLOOR PLAN - MECHANICAL DEMOLITION

FIRST FLOOR PLAN - MECHANICAL DETAIL OF MODULAR DOAS-1

MECHANICAL DETAILS MECHANICAL SCHEDULES

M7.1 MECHANICAL CONTROLS

ELECTRICAL

MECHANICAL

ELECTRICAL DRAWINGS

HVAC UPGRADES LAUDERDALE COUNTY ANIMAL SHELTER

MARION, MISSISSIPPI

CONSTRUCTION DOCUMENTS **SEPTEMBER 19, 2024**

PROJECT MAP

ANIMAL SHELTER -PROJECT LOCATION





JACKSON, MS 39206 PHONE: (601) 362-3552 FAX: (601) 366-6418

CONSULTANTS:

ELECTRICAL ENGINEER SCHULTZ & WYNNE, P.A 4523 OFFICE PARK DR. JACKSON, MS 39206 T: (601) 982-3313

PROJECT:

PROJECT DRAWN BY **CHECKED BY** REV: 0 IFC 09/19/24

SHEET TITLE:

TITLE SHEET

SHEET NUMBER

4523 OFFICE PARK DR.

JACKSON, MS 39206

T: (601) 982-3313

PROJECT NUMBER:	22.006
DATE:	09/19/202
DRAWN BY:	DE
CHECKED BY:	CM
REV: 0_IFC 09/19	9/24
	-




SHEET TITLE:

MECHANICAL ABBREVIATIONS, LEGEND AND NOTES

SHEET NUMBER

M0.1

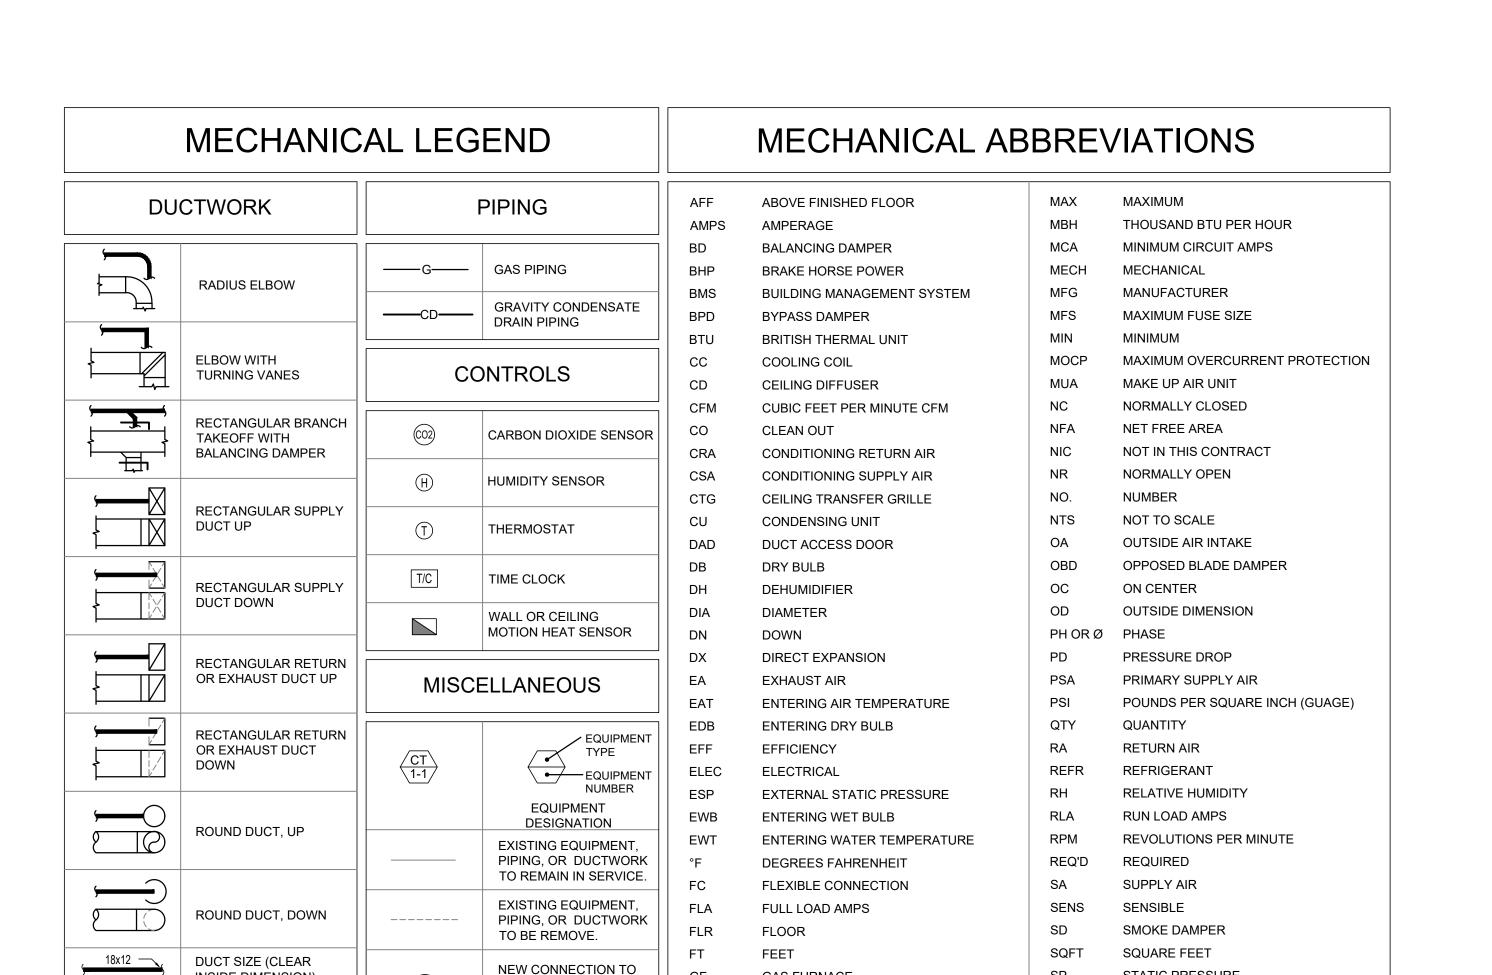

NEW CONNECTION TO

DUCTWORK AND/OR

NORTH DIRECTION

AIR THROW PATTERN WHERE

INDICATED (ALL DEVICES ARE

EXISTING PIPING,

EQUIPMENT

SYMBOL

DIFFUSER SCHEDULE TAG (AND

LENGTH OR NECK SIZE FOR LINEAR

OR SIDEWALL LOUVER DIFFUSERS

4 -WAY THROW IF NOT

DIFFUSER, RETURN, & **EXHAUST GRILLE TAG**

INDICATED OTHERWISE)

GF

GPM

HC

KW

LBS

LRA

LWT

HORIZ

GAS FURNACE

HEATING COIL

HORIZONTAL

HOUR

KILOWATT

POUNDS

HORSEPOWER

INSIDE DIMENSION

LOCK ROTOR AMPS

MOTORIZED DAMPER

MIXED AIR TEMPERATURE

LEAVING AIR TEMPERATURE

LEAVING WATER TEMPERATURE

GALLONS PER MINUTE

STATIC PRESSURE

VARIABLE AIR VOLUME

VOLUME DAMPER

VENT THRU ROOF

WALL SUPPLY REGISTER

WET BULB

VARIABLE AIR VOLUME DAMPER VENTILATION EXHAUST AIR

VARIABLE FREQUENCY DRIVE

TRANSFER AIR

TYPICAL

VOLTS

VERT

VFD

VTR

WB

INSIDE DIMENSION)

INDICATES PLAN SIZE

ROUND DUCT DIAMETER

SIZE (CLEAR INSIDE

VOLUME DAMPER

4 WAY CLG DIFFUSER

FIRST FIGURE

DIMENSION)

> 18x12

X

GENERAL NOTES:

- A. REMOVE BUILDING COMPONENTS AS REQUIRED TO REMOVE EXISTING HVAC SYSTEMS/EQUIPMENT AND INSTALL NEW SYSTEMS/EQUIPMENT.
- B. CONTRACTOR SHALL BE RESPONSIBLE FOR CUTTING, PATCHING, REPAIRING AND REFINISHING ALL SURFACES AND FINISHES DAMAGED OR DISTURBED AS PART OF WORK PERFORMED UNDER THIS CONTRACT.

PLAN NOTES:

- REMOVE EXISTING GAS FIRED AIR HANDING UNIT, CONTROLS, IN ITS ENTIRETY. CAP FLUE BELOW ROOF WATER TIGHT.
- 2. REMOVE EXISTING CONDENSING UNIT, REFRIGERANT PIPING, CONTROLS, IN ITS ENTIRETY.
- 3. REMOVE EXISTING SIDEWALL MOUNTED EXHAUST FAN IN ITS ENTIRETY. PATCH WALL TO MATCH EXISTING.
- 4. REMOVE EXISTING OUTSIDE AIR INTAKES. PATCH WALL TO MATCH EXISTING.
- REMOVE EXISTING SUPPLY AIR DUCTWORK AND DIFFUSERS IN ITS ENTIRETY.
- REMOVE EXISTING RETURN AIR DUCTWORK AND GRILLES IN ITS ENTIRETY.
- 7. REMOVE EXISTING EXHAUST DUCTWORK AND GRILLES IN ITS ENTIRETY.
- 8. REMOVE EXISTING TRANSFER AIR DUCTWORK AND GRILLES.

E

ENGINEERING

RESOURCE GROUP
350 EDGEWOOD TERRACE DRIVE
JACKSON, MS 39206
PHONE: (601) 362-3552
FAX: (601) 366-6418

CONSULTANTS:

ELECTRICAL ENGINEER SCHULTZ & WYNNE, P.A. 4523 OFFICE PARK DR. JACKSON, MS 39206 T: (601) 982-3313

PROJECT:

HVAC UPGRADES AUDERDALE COUNTY ANIMAL SHELTER

_	
PROJECT	
NUMBER:	22.006
DATE:	09/19/2024
DRAWN BY:	DB
CHECKED BY:	СМ
REV: 0 IFC 09/19/2	4

2 3____



SHEET TITLE:

FIRST FLOOR PLAN -MECHANICAL DEMOLITION

SHEET NUMBER

MD1.1

FIRST FLOOR PLAN - MECHANICAL DEMOLITION

SCALE: 1/4" = 1'-0"

GENERAL NOTES:

NEW DUCTWORK.

STOPPING ASSEMBLY.

INSTALLATION.

INSULATION)

PLAN NOTES:

A. CONTRACTOR SHALL BE RESPONSIBLE FOR CUTTING, PATCHING, REPAIRING AND REFINISHING ALL SURFACES AND FINISHES DAMAGED OR DISTURBED AS PART OF WORK

PERFORMED UNDER THIS CONTRACT. B. CONTRACTOR SHALL BE RESPONSIBLE OF

FRAMING, FLASHING, AND WEATHERPROOFING NEW EXTERIOR WALL PENETRATIONS FOR

C. TRANSFER AIR DUCTS SHALL BE LINED WITH 1"

SPECIFICATION SECTION 230713 - DUCT

D. PROVIDE AND INSTALL 1-1/2 HR FIRE DAMPER IN SUPPLY AND TRANSFER AIR DUCTS

PENETRATING THE FIRE RATED DEMISING

WALL. FIRE DAMPERS SHALL BE EQUAL TO

RUSKIN DIBD2. FIRE CAULK AROUND FIRE DAMPER TO PROVIDE A UL LISTED FIRE

1. SUPPLY AIR DUCTWORK TO RISE UP WALL AND ENTER ATTIC SPACE. ADJUST CEILING HEIGHT

2. EXHAUST AIR DUCTWORK TO RISE UP WALL

HEIGHT AS REQUIRED FOR DUCTWORK

3. ROUTE 2" CONDENSATE DRAIN TO NEAREST STORM OR SANITARY SEWER BELOW GRADE.

PAD AND TERMINATE WITH HUB DRAIN.

REQUIRED FOR LEVEL UNIT OPERATION. PROVIDE MIN. 32" UNIT CURB FOR DOWN

DISCHARGE DUCTWORK INSTALLATION. 5. CONNECT NEW 1-1/4" GAS LINE TO NEAREST 1-1/4 OR LARGER. FIELD VERIFY. SET

EQUIPMENT PAD. SEE PAD MOUNTED HVAC

CONNECT 6" TYPE 6 ACOUSTICAL INSULATED

FIRE DAMPER (TYPICAL BOTH SIDES OF THE

8. PROVIDE OPPOSED BLADE VOLUME DAMPER IN

RA GRILLE. BALANCE TO SPECIFIED CFM.

FIRE DAMPER). REFER TO SPECIFICATION SECTION 233113 - METAL DUCTS FOR TYPE 6 ACOUSTICAL FLEXIBLE DUCT SPECIFICATIONS.

FLEXIBLE DUCT TO THE EXHAUST GRILLE AND

6. NEW 6" THICK REINFORCED CONCRETE

PACKAGED UNIT DETAIL SHEET M5.1.

REGULATOR FOR 410 CFH.

STUB UP NEW SEWER LINE IN NEW CONCRETE

4. CONTRACTOR TO INSTALL MIN 6" REINFORCED

CONCRETE PAD IN EXISTING PARKING LOT AS


AS REQUIRED FOR DUCTWORK INSTALLATION.

AND ENTER ATTIC SPACE. ADJUST CEILING

THICK DUCT LINER (TYPE AL PER

PROJECT:

HVAC UF AUDERDA ANIMAL

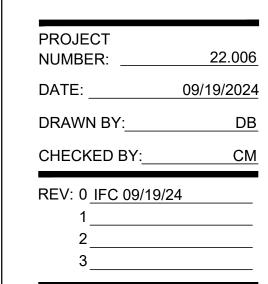


SHEET TITLE:

FIRST FLOOR PLAN -MECHANICAL

SHEET NUMBER


M1.1

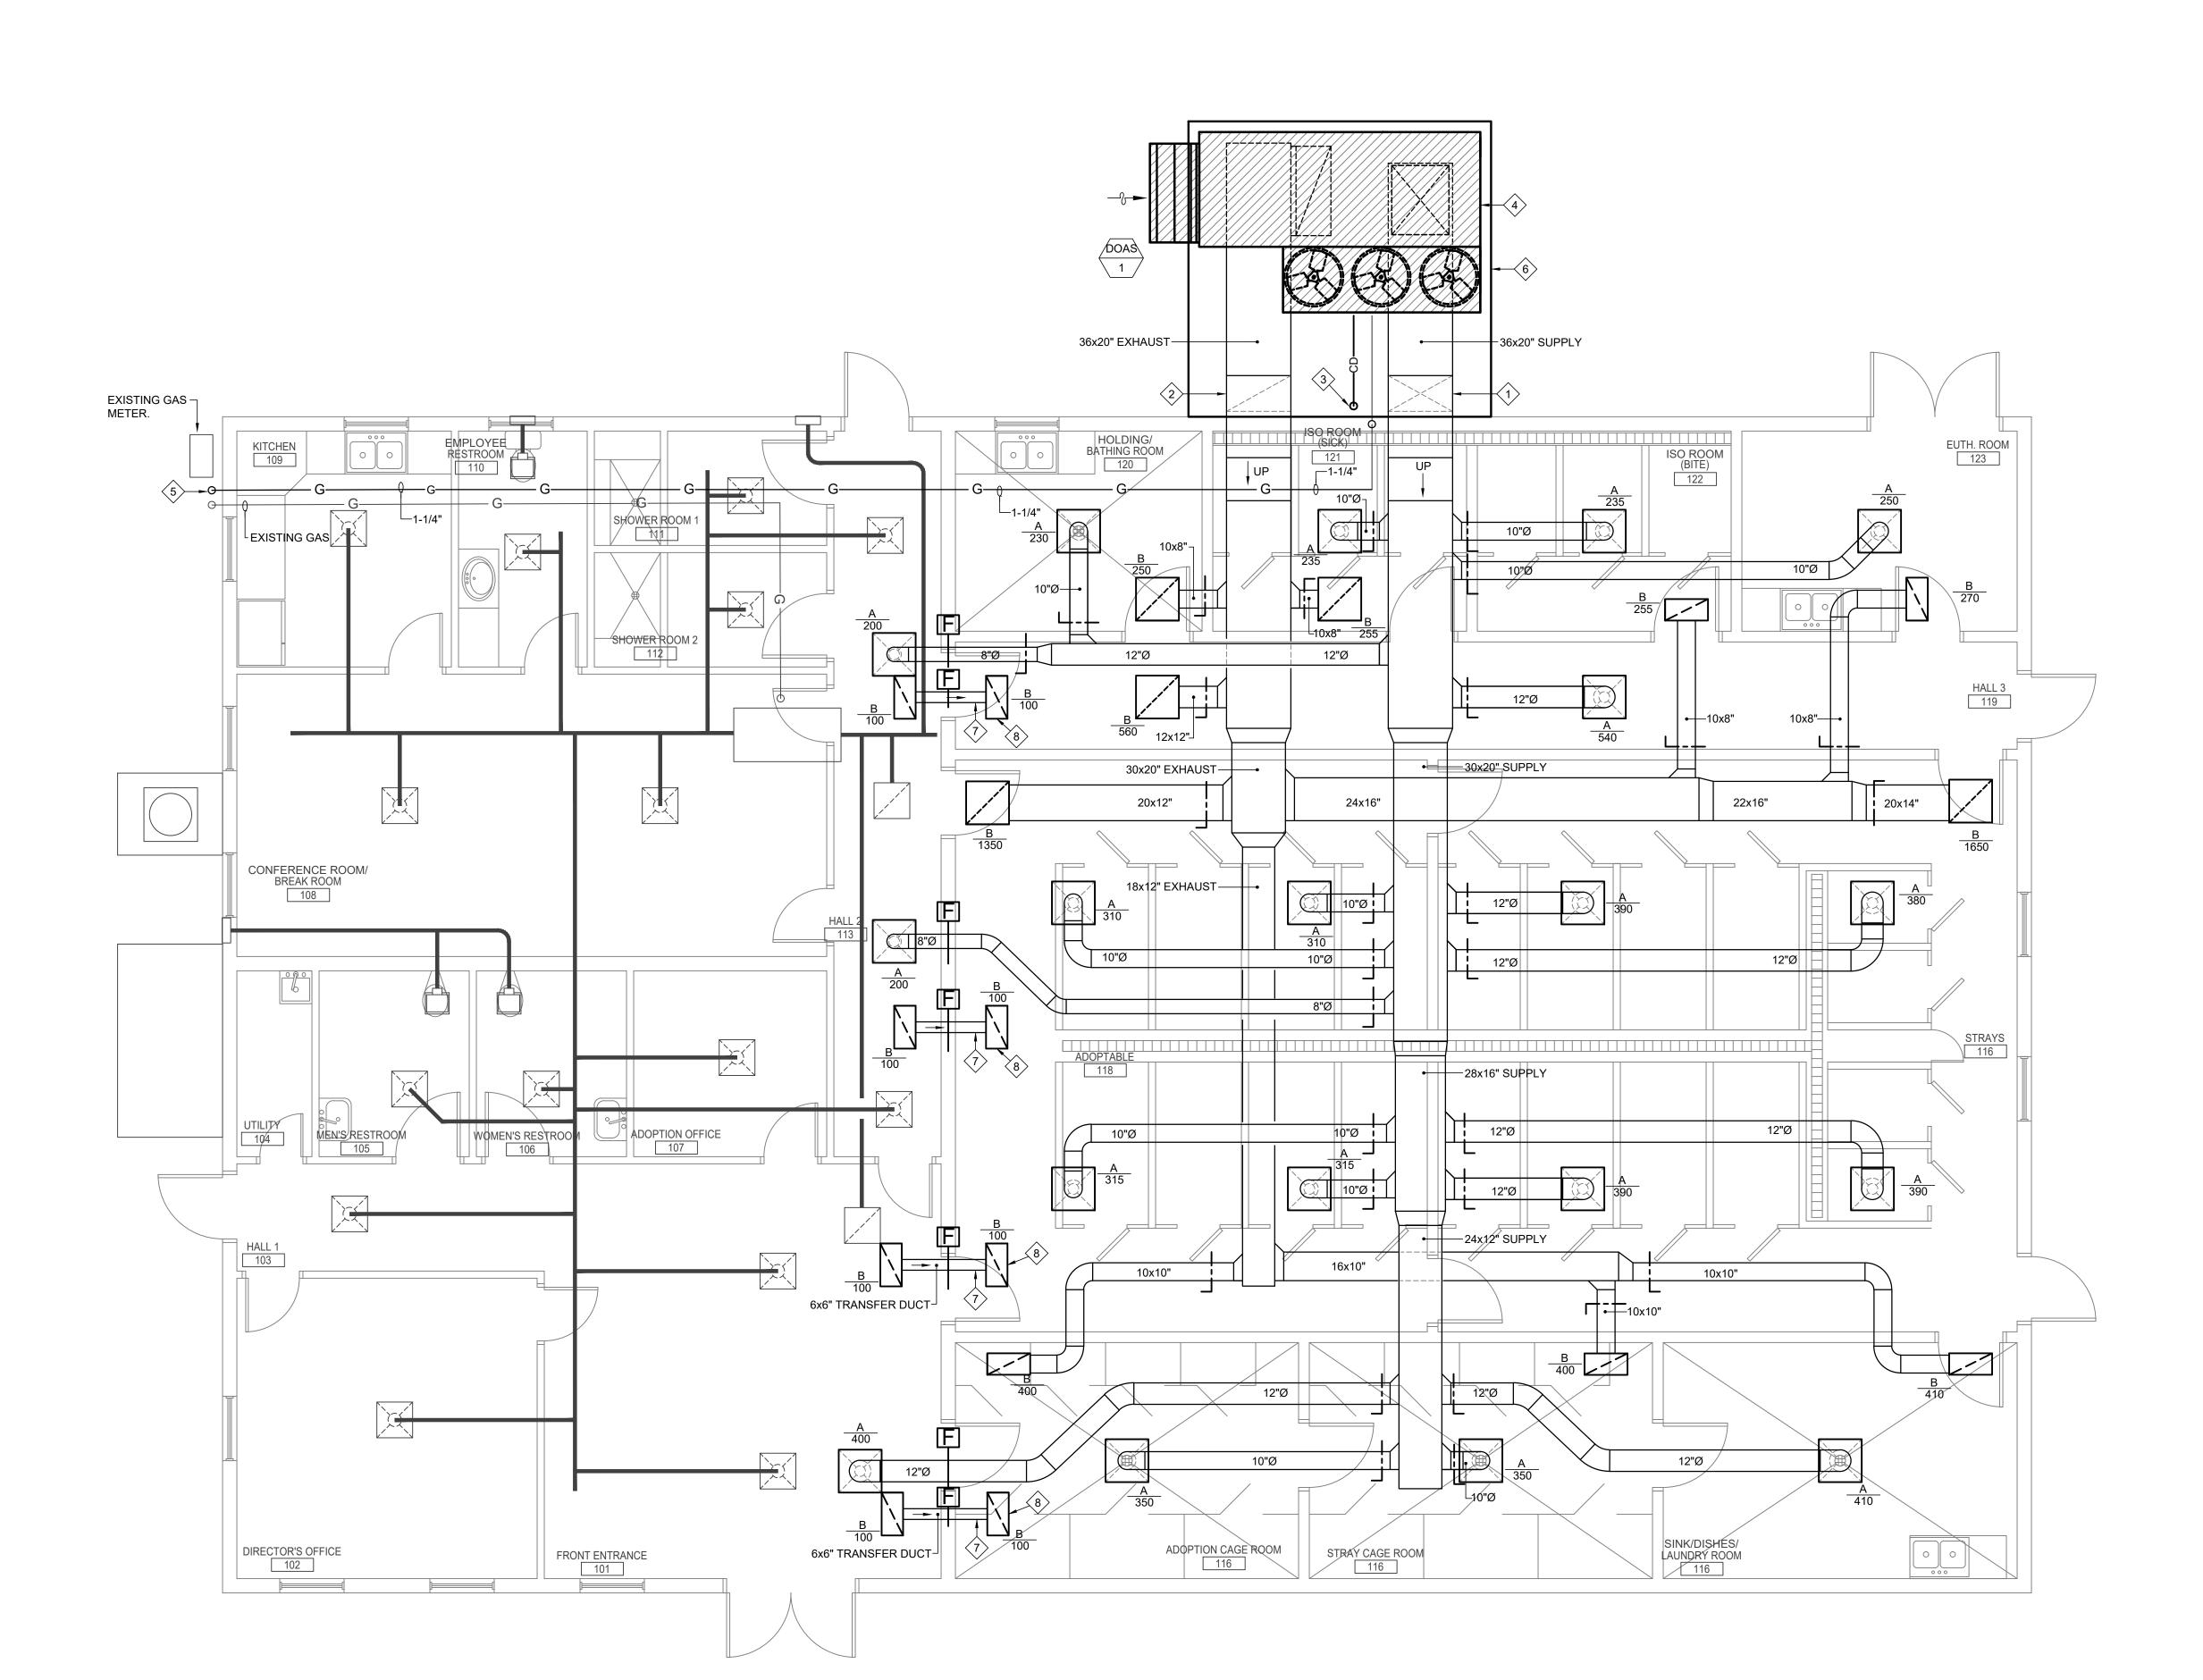

FIRST FLOOR PLAN - MECHANICAL
SCALE: 1/4" = 1'-0"

CONSTRUCTION DOCUMENTS

PHONE: (601) 362-3552 FAX: (601) 366-6418

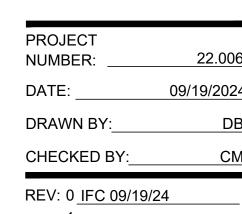




SHEET TITLE:


DETAIL OF MODULAR DOAS-1

SHEET NUMBER


M4.1

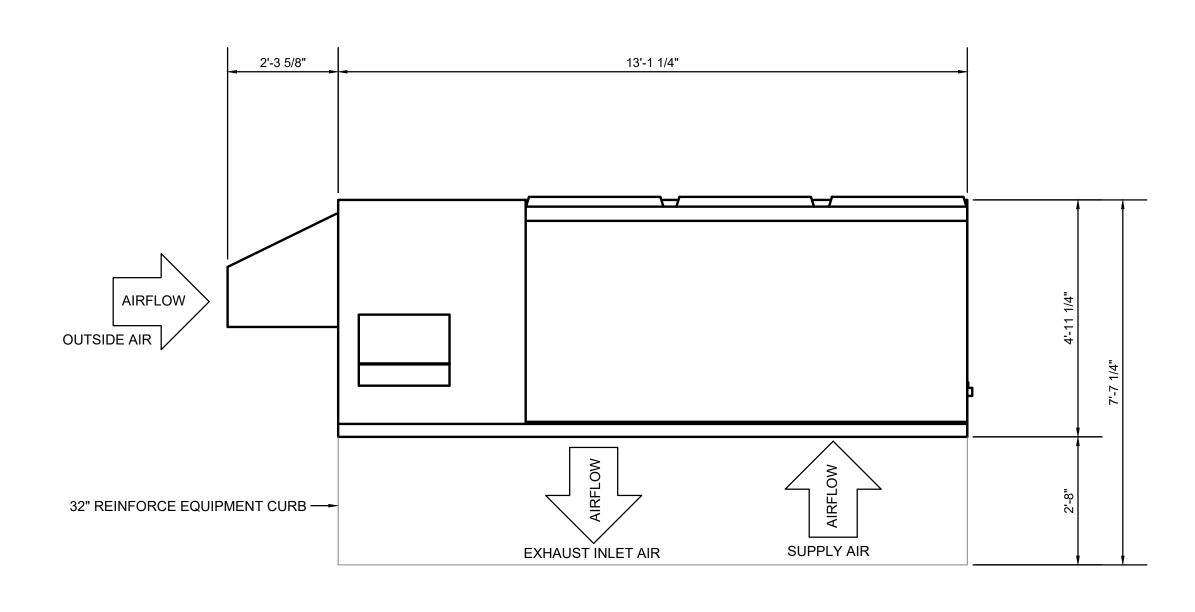



DOAS SIDE ELEVATION VIEW

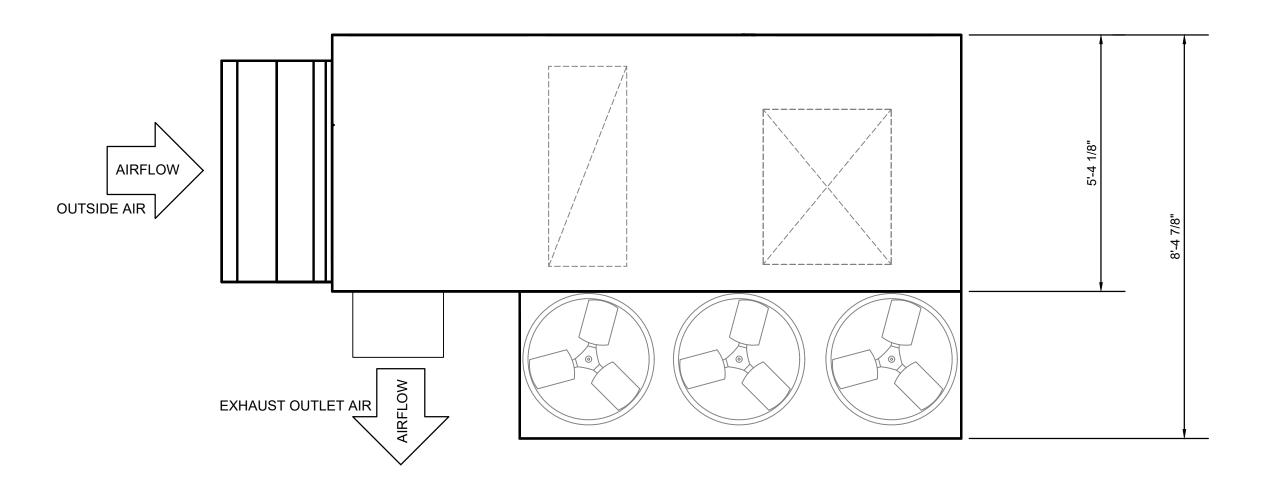



DOAS PLAN VIEW

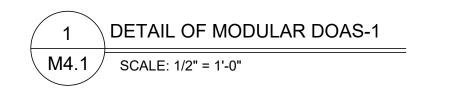

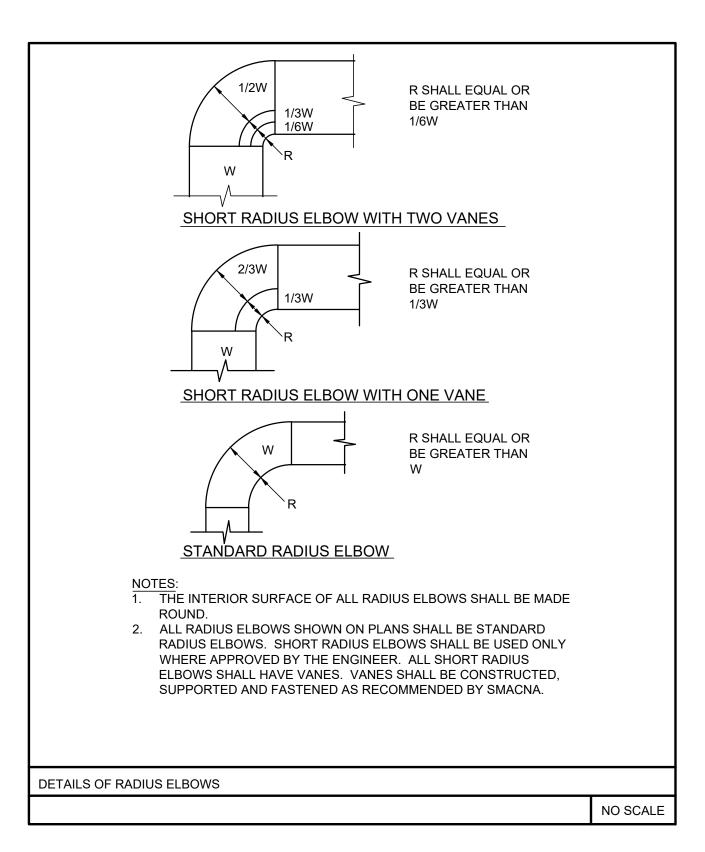


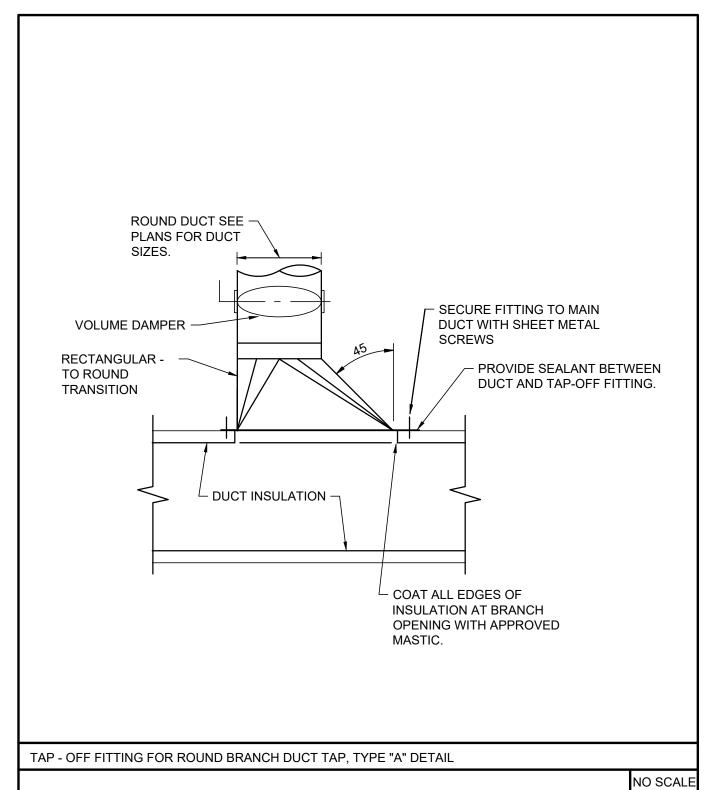


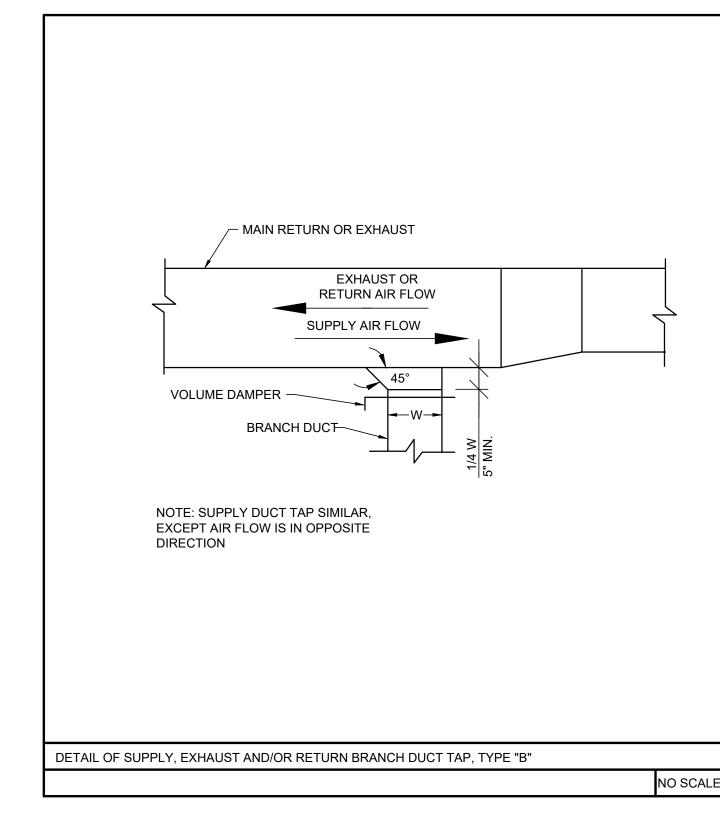


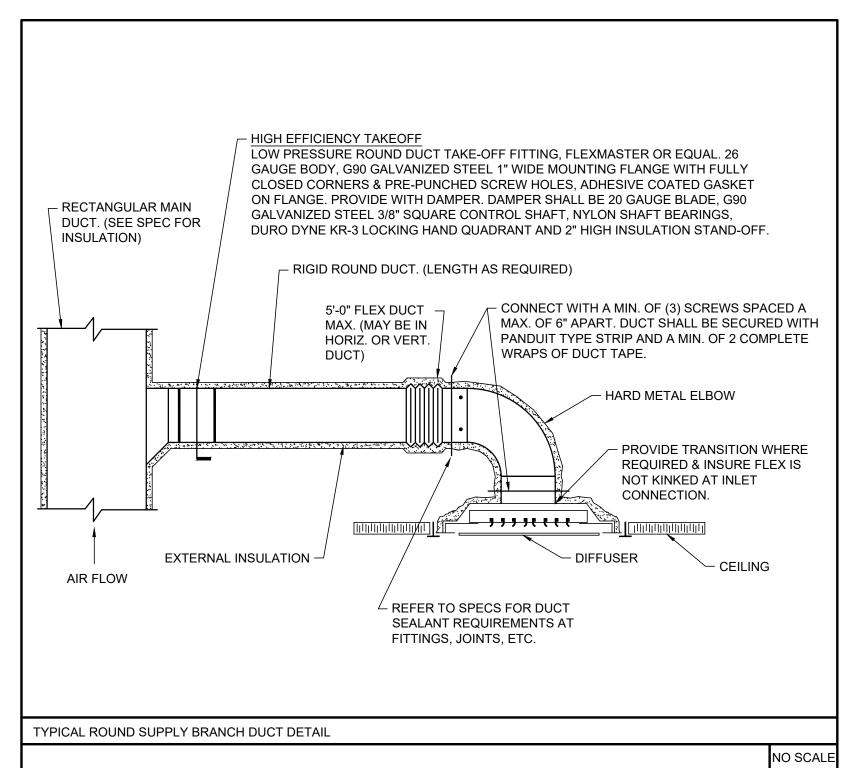

NO SCALI

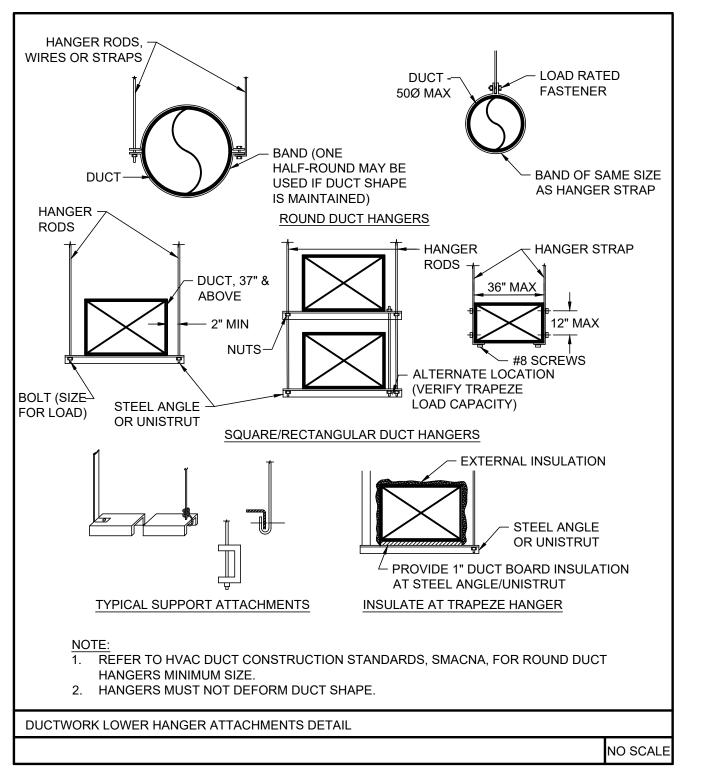

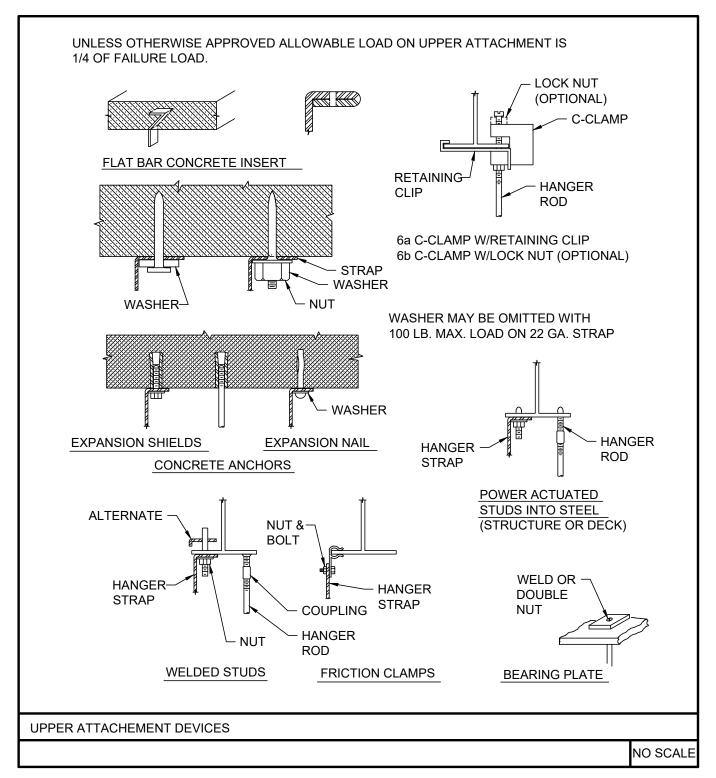

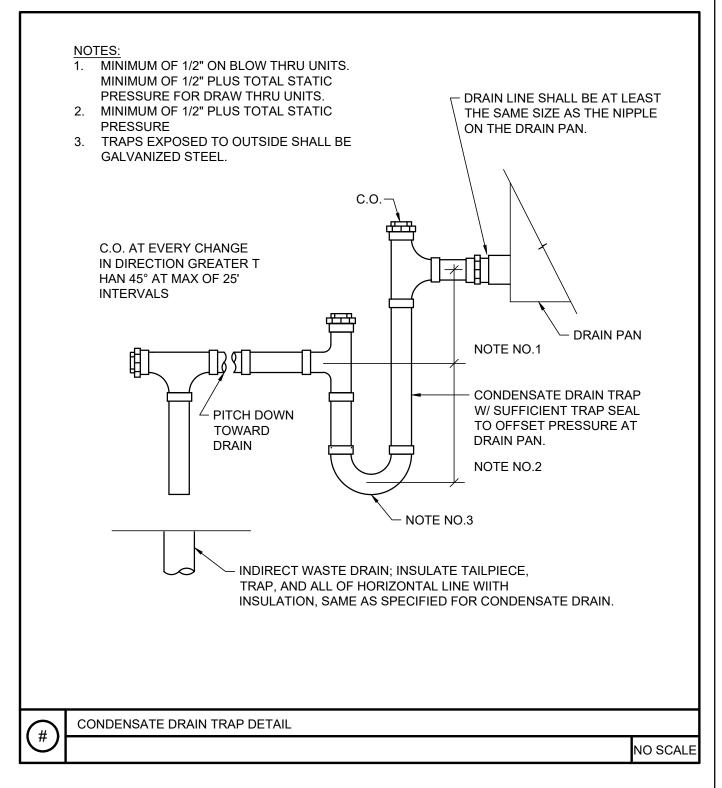



350 EDGEWOOD TERRACE DRIVE JACKSON, MS 39206 PHONE: (601) 362-3552 FAX: (601) 366-6418

CONSULTANTS:

ELECTRICAL ENGINEER SCHULTZ & WYNNE, P.A 4523 OFFICE PARK DR. JACKSON, MS 39206 T: (601) 982-3313

PROJECT:

HVAC UPGRADES AUDERDALE COUNTY ANIMAL SHELTER

20102 20102 20102 20102 20102 20102 20102

SHEET TITLE:

MECHANICAL DETAILS

SHEET NUMBER

M5.1

			SUPPLY FA	l		EXHA	UST FAN				DX COOLING			HGRH		GAS HEAT			EN	ERGY WHE	EL (SUMME	ER)			Eľ	IERGY W	HEEL (WINTER)		I	FILTER			ELECT	RICAL DATA		OP
TAG	BASIS OF DESIGN	TOTAL CFM	ESP QTY	MOTOR HP	TOTAL CFM	ESP	QTY	MOTOR HP	EDB EWB	LDB LWB	CAPACITY, MBH TOTAL SENS	FPI MIN EER	MIN IEER	(MBH)	EAT (INPUT OUTPU (MBH) (MBH)	T MIN EFF	. EDB	OUTDOOR AII EWB LDB	LWB ED	EXHAU:	ST AIR LDB LWB	EFF.	OL EDB E	UTDOOR AIR EWB LDB LWB	EDB I	XHAUST AIR EWB LDB L	WB EFF.	TYPE	DEPTH	MERV	V/Ø	COMPRESSOR RLA	CONDENSER FLA	MCA	MOP (LBS
DOAS 1	AAON RN-025-8-0	6,200	1.0 1	7.5	5,800	1.0	1	5	78.3 69.6	52.3 52.2	323.47 308.4	12 6 11.6	12.7	118	20.0	270 218	80%	86.0	77.3 78.3	69.6 75.	.0 62.4	83.0 71.5	68.8	20.0 1	19.0 54.0 40.9	70.0	50.0 32.7 2	8.8 67.0	PLEATED	4"	8	208/3	48.1 48.1	(3) @ 7	173	200 3,72

REMARKS

CONFIGURE FOR SPACE TEMPERATURE, HUMIDITY CONTROL, & BUILDING PRESSURE CONTROL, PROVIDE WITH 10:1 MODULATING GAS HEAT, HIGH EFFICIENCY EC SUPPLY/EXHAUST MOTOR, OUTSIDE AIR, RETURN AIR MODULATING POWERED 115V GFI OUTLET, PHASE FAILURE MONITOR, BACNET IP CARD, REMOTE CONTROLLER, SPACE TEMPERATURE AND HUMIDITY SENSOR, BUILDING PRESSURE TRANSDUCER & ACCESSORIES, MIN 32" CURB.

351-600

601-850

851-1200

12"Ø

14"Ø

16"Ø

14x10"

16x12"

18x16"

12x12"

14x14"

16x16"

12"Ø

14"Ø

16"Ø

14x10"

16x12"

18x16"

AIR	DISTRIBUTION	N DEVICE SO	CHEDULE											
TAG	TYPE MANUFACTURER & MODEL NO. NECK SIZE FACE SIZE REMARKS													
Α	CEILING MOUNTED SUPPLY AIR DEVICE	PRICE SPD	SEE PLANS/ SCHEDULE BELOW	SEE PLANS/ SCHEDULE BELOW	24"x24" OR 12"x12" FACE SIZE AS INDICATED ON PLANS. PROVIDE ALL SURFACE MOUNTED GRILLES WITH PLASTER FRAME MOUNT. NECK SIZE TO BE AS INDICATED ON PLANS OR CONNECTION SCHEDULE BELOW.									
В	CEILING MOUNTED EXHAUST AIR DEVICE	PRICE 80	SEE PLANS/ SCHEDULE BELOW SCHEDULE BELOW 24x24" OR 24"x12" FACE SIZE AS INDICATED ON PLANS. PROVIDE ALL SURFACE MOUNTED GRILLES WITH SCREW HOLES. NECK SIZE TO BE AS INDICATED ON PLANS OR CONNECTION SCHEDULE BELOW.											
NOTES:	AIR DEVICE CONNECTION SCHEDULE 1. CEILING DIFFUSERS ARE 4-WAY UNLESS OTHERWISE NOTED BY SHADING ON PLANS.													
2. RE	FER TO ARCHITECTURAL D	RAWINGS FOR CEILING	TYPE AND CONSTRUCTI	ON DETAILS.	FLECTED CEILING PLAN.	AIR QUANTITY	CEILING MOUNTED	SIDEWALL MOUNTED	EXHAUST AIR GRILLE NECK SIZE	BRANCH DUCT SIZE				
	FER TO ARCHITECT FOR FII CE SIZE TO BE NECK SIZE P		DEVICES.			(CFM)	NECK SIZE	NECK SIZE		ROUND	ALTERNATE RECTANGULAR DUCT			
6. PF	ROVIDE OPPOSED BLADE VC	DLUME DAMPER IN TRAI	NSFER AIR GRILLES (QTY	4.)		0-100	6"Ø	8x4"	8x8"	6"Ø	8x4"			
						101-200	8"Ø	10x6"	8x8"	8"Ø	10x6"			
						201-350	10"Ø	12x8"	10x10"	10"Ø	12x8"			



RESOURCE GROUP
350 EDGEWOOD TERRACE DRIVE
JACKSON, MS 39206
PHONE: (601) 362-3552
FAX: (601) 366-6418

CONSULTANTS:

ELECTRICAL ENGINEER SCHULTZ & WYNNE, P.A. 4523 OFFICE PARK DR. JACKSON, MS 39206 T: (601) 982-3313

PROJECT:

HVAC UPGRADES LAUDERDALE COUNTY ANIMAL SHELTER

SHEET TITLE:

MECHANICAL SCHEDULES

SHEET NUMBER

M6.1

OUTDOOR AIR UNIT (DOAS) CONTROL SCHEMATIC

M7.1 NO SCALE

NOTES (#>

CONTROL DEVICES PROVIDED BY DOAS MANUFACTURER, FIELD INSTALLED AND WIRED BY DIVISION 23 HVAC CONTRACTOR.

DOAS SEQUENCE OF OPERATION

General: Constant Volume (CV) Dedicated Outdoor Air System (DOAS) with energy recovery wheel, Direct Expansion (DX) cooling coil, hot-gas reheat coil, natural gas furnace, supply fan and exhaust fan. Unit shall be controlled by its internal Direct-Digital Controller.

DOAS System Modes: DOAS system modes are the same as the mode of the Zone Group served by the system. When Zone Groups served by the DOAS are in different modes, the following hierarchy applies (highest one sets DOAS mode):

Occupied mode 2. Unoccupied mode

Fan Control:

- . Supply Fan and Exhaust Fan Start/Stop
- 1.1. DOAS supply fan and exhaust fans shall run when the system is Occupied and shall be off in Unoccupied Mode.
- 1.2. DOAS unit controller shall command the outdoor and exhaust air dampers open whenever the DOAS is enabled. Dampers shall be closed when unit is disabled.
- 1.3. DOAS shall be hard-wire interlocked through smoke detectors. Unit shall be shutdown when the smoke detector auxiliary contacts are energized.

2. Supply Fan Speed Control:

2.1. Supply fan VFD speed shall be set to run at the speed corresponding to its design air flow rate when the fan is proven on. Division 23 HVAC contractor shall coordinate with Testing, Adjusting, and Balancing Agency to determine exact VFD speed setpoint.

3. Exhaust Fan Speed Control:

3.1. Exhaust fan VFD speed shall be set to run at the speed corresponding to its design air flow rate when the fan is proven on. Division 23 HVAC contractor shall coordinate with Testing, Adjusting, and Balancing Agency to determine exact VFD speed setpoint. Exact exhaust air flow rate shall be determined by TAB Agency that provides both code required exhaust and a positive building pressurization of 0.05 inches w.c. (adjustable).

Enthalpy Wheel Control:

- Energy recovery wheel control shall be enabled when the supply fan is proven on.
- 2. Energy recovery wheel control logic:
- 2.1. OA temperature < 55°F (adjustable): Leaving energy recovery wheel air temperature (outdoor air side) shall be controlled to the supply air temperature setpoint using a PID loop whose output is mapped to sequence the energy recovery wheel and wheel bypass 2.2. 55°F' >= OA temperature >= 69°F (adjustable): Energy recovery wheel is off and bypass
- 2.3. OA temperature > 69°F (adjustable): Energy recovery wheel shall be at full speed and
- bypass dampers closed.

Cooling Mode:

Unit controller shall measure the zone temperature and stage the cooling to maintain the zone cooling set point.

Heating Mode:

Unit controller shall measure the zone temperature and stage the heating to maintain the zone heating set point.

<u>Dehumidification Mode</u>:

- Dehumidification mode shall be enabled when the zone relative humidity exceeds the high-limit set point for 10 minutes. Initial high-limit set point shall be 55% RH.
- Unit controller shall measure the zone relative humidity and override the cooling sequence to maintain the zone humidity at or below 55% (adj.). During dehumidification mode the hot gas reheat shall be modulated to maintain the zone temperature at the Occupied zone cooling set

Safeties and Interlocks:

. Supply fan shall be hardwire interlocked through the unit smoke detector(s) to shut down the unit

ENGINEERING RESOURCE GROUP

> 350 EDGEWOOD TERRACE DRIVE JACKSON, MS 39206 PHONE: (601) 362-3552 FAX: (601) 366-6418

CONSULTANTS:

ELECTRICAL ENGINEER SCHULTZ & WYNNE, P.A. 4523 OFFICE PARK DR. JACKSON, MS 39206 T: (601) 982-3313

PROJECT:

HVAC UF AUDERDA ANIMAL

PROJECT 09/19/2024 DRAWN BY: CHECKED BY: REV: 0 IFC 09/19/24

SHEET TITLE:

MECHANICAL CONTROLS

SHEET NUMBER

M7.1

				CHEDULE
CIRCUIT	POLES	AMPS	LOAD	REMARKS
1	3	200	DOAS-1	VOLTAGE: 208Y/120
2	3	200	PNL. LP	PHASE: 3 WIRE: 4 WITH GROUND BUS
3	3	225	SPACE	MAIN BUS: 400A NEUT. BUS: 400A
4	3	225	SPACE	MOUNTING: NEMA 3R
				MIIN. K.A.I.C.: 22

PAI	NEL	"LP	" SC	SCHEDULE						
CIRCUIT	POLES	AMPS	LOAD	REMARKS						
1–29 30–33 34–35	1 2 2	20 50 30	EX'G EX'G EX'G	VOLTAGE: 208Y/120 PHASE: 3 WIRE: 4 WITH GROUND BUS MAIN BUS: 200A NEUT. BUS: 200A MOUNTING: SURFACE MIN. K.A.I.C.: 22						
RE-SERVE	ALL ACT	IVE EX'G	BRANCH CIF	RCUITS FROM NEW						


PANEL. ARRANGE C/B'S AS REQUIRED & CONNECT LOADS

PER EX'G CONSTRUCTION.

ELECTRICAL SERVICE & DISTRIBUTION SYS.

SCHEMATIC POWER RISER DIAGRAM

NO SCALE

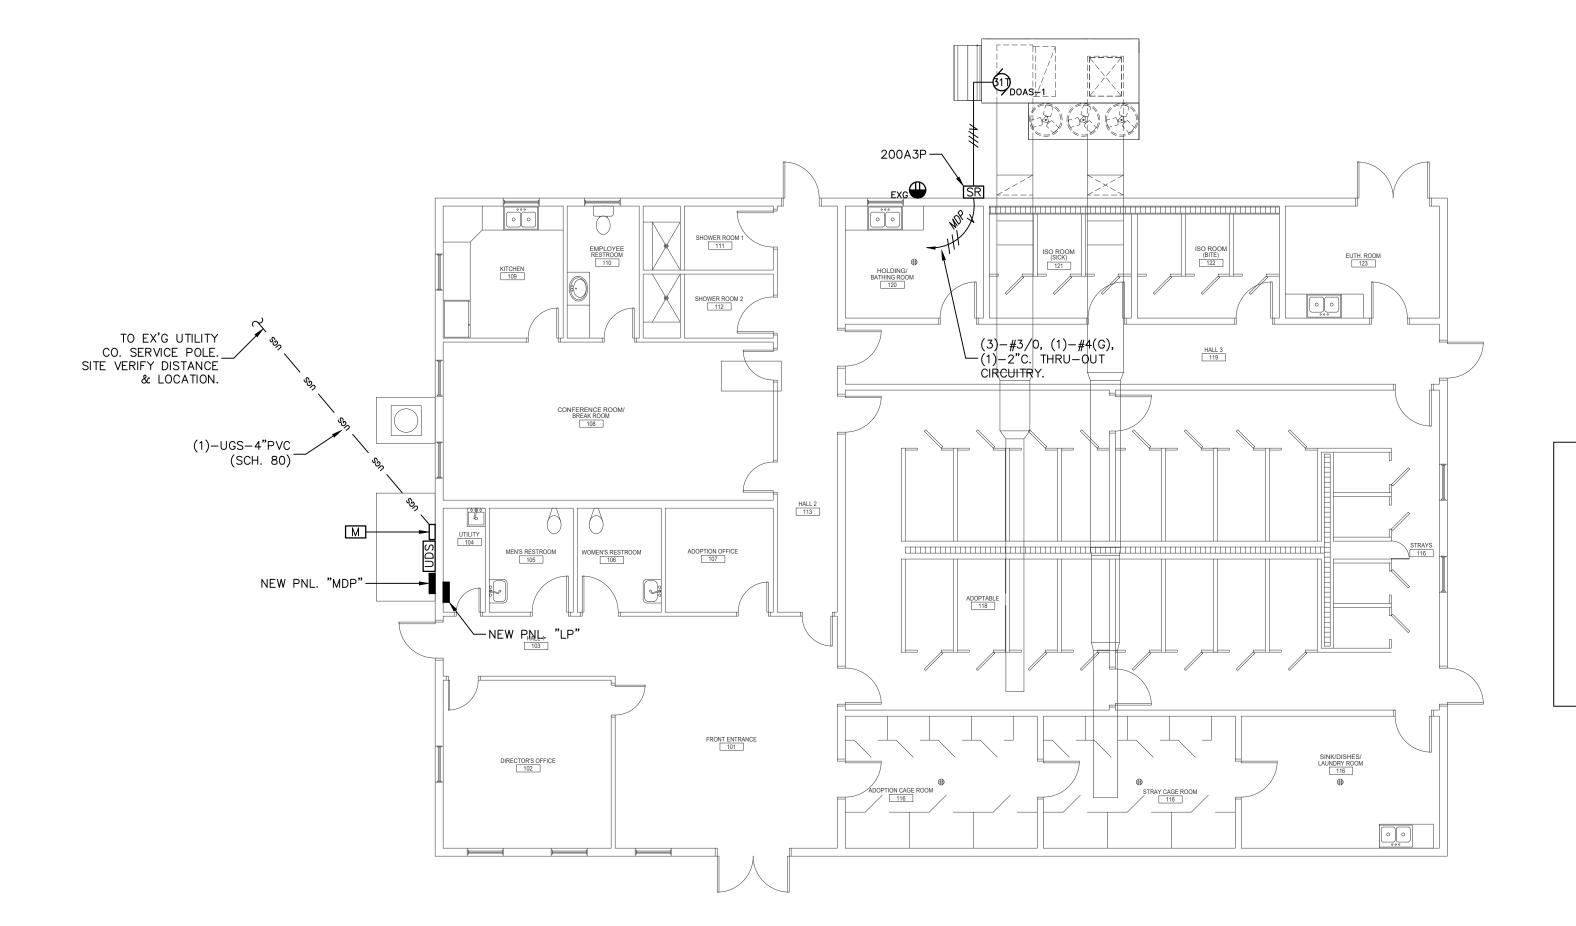

ELECTRICAL FLOOR PLAN

SCALE: 1/8" = 1'-0"

POWER SYSTEMS - NEW WORK

GENERAL DEMOLITION NOTES:

- DEMOLITION WORK TO BE SCHEDULED & PERFORMED AS REQUIRED TO COMPLY WITH THE PROJECT PHASING & AS REQUIRED TO MAINTAIN ELECTRICAL SERVICE TO THE ACTIVE PORTIONS OF THE BUILDING DURING NORMAL BUSINESS HOURS.
- 2. DISCONNECT & REMOVE EX'G ELECTRICAL SERVICE(S) TO MECHANICAL EQUIPMENT INDICATED ON THE MECHANICAL DRAWINGS.
- 3. DISCONNECT & REMOVE THE EX'G 1-PHASE ELECTRICAL PANEL & ASSOCIATED ELECTRICAL SERVICE ENTRANCE & METERING. REMOVE SERVICE ENTRANCE TO UTILITY POLE CONNECTIONS. MAINTAIN & PROTECT EX'G ACTIVE BRANCH CIRCUITS FOR CONNECTION TO NEW EQUIPMENT.

POWER RACEWAYS & BOXES SYMBOLS LEGEND

BRANCH CIRCUIT (CONDUIT & WIRING) CONCEALED ABOVE CEILING OR IN WALL, NUMBER OF CONDUCTORS, (V) INDICATES EQUIP. GROUNDING CONDUCTOR SIZED PER BRANCH CIRCUIT UNLESS INDICATED OTHERWISE.

BRANCH CIRCUIT (CONDUIT & WIRING) CONCEALED IN/UNDER FLOOR SLAB PER THE SPECS. OR BELOW THE FINISHED GRADE PER THE SPECS., NUMBER OF CONDUCTORS WITH EQUIPMENT GROUNDING CONDUCTOR (V).

BRANCH CIRCUIT (CONDUIT & WIRING), FLEXIBLE METALLIC CONDUIT (FMC) UNLESS INDICATED OTHERWISE, NUMBER OF CONDUCTORS WITH EQUIPMENT GROUNDING CONDUCTOR (V).

BRANCH CIRCUIT (CONDUIT & WIRING), LIQUID-TIGHT FLEXIBLE METALLIC CONDUIT (LFMC), NUMBER OF CONDUCTORS WITH EQUIPMENT GROUNDING CONDUCTOR (V).

1-2-3 NL HC BR

— UGS —

BRANCH CIRCUIT(S) (CONDUIT & WIRING) HOMERUN, PANEL & CIRCUIT DESIGNATION(S), ROUTE CONCEALED, NUMBER OF CONDUCTORS, (V) INDICATES EQUIPMENT GROUNDING CONDUCTOR, MINIMUM 3/4" CONDUIT, ALL HOMERUNS GREATER THAN 75 FT. IN LENGTH SHALL USE MINIMUM #10 AWG CONDUCTORS.

BRANCH CIRCUIT(S) (CONDUIT & WIRING) HOMERUN, PANEL & CIRCUIT DESIGNATION(S), ROUTE CONCEALED IN/UNDER FLOOR SLAB OR BELOW FINISHED GRADE PER THE SPECS. NUMBER OF CONDUCTORS, (V) INDICATES EQUIPMENT GROUNDING CONDUCTOR, MINIMUM 3/4" CONDUIT, ALL HOMERUNS GREATER THAN 75 FT. IN

SURFACE JUNCTION BOX WITH COVER, SIZE & MOUNTING HEIGHT AS INDICATED, MINIMUM BOX SIZE SHALL BE 4" SQUARE.

FLUSH JUNCTION BOX WITH PLATE, SIZE & MOUNTING HEIGHT AS INDICATED, MINIMUM BOX SIZE SHALL BE 4"

LENGTH SHALL USE MINIMUM #10 AWG CONDUCTORS.

SQUARE WITH 1 GANG RAISED COVER.

BRANCH CIRCUIT HOMERUN JUNCTION BOX, 4" SQUARE MINIMUM, MOUNT ABOVE ACCESSIBLE CEILING WHERE PRESENT, AT OVERHEAD STRUCTURE OR AS INDICATED.

DUCT BANK & CONDUCTORS, UNDERGROUND, SECONDARY, CONDUCTOR & CONDUIT ELECTRICAL CHARACTERISTICS AS INDICATED, LOCATION & ROUTING SHOWN ARE APPROXIMATE & REPRESENTATIVE.

EQUIPMENT ELECTRICAL SERVICES SYMBOLS LEGEND

EQUIPMENT POWER CONNECTION MARK, SEE EQUIPMENT ELEC. SERVICE SCHEDULE FOR BRANCH CIRCUIT & CONNECTION REQUIREMENTS, LOCATION SHOWN IS APPROXIMATE & REPRESENTATIVE.

BRANCH CIRCUIT & POWER CONNECTION TO ELECTRIC MOTOR, PROVIDE & CONNECT THRU PROPER DISCONNECT SWITCH ADJACENT TO UNIT, LOCATION SHOWN IS APPROXIMATE, CIRCUIT DESIGNATION.

BRANCH CIRCUIT & POWER CONNECTION TO EXHAUST FAN, INSTALL & CONNECT THRU CONTROL DEVICE &

INTEGRAL DISCONNECT SWITCH, LOCATION SHOWN IS APPROXIMATE, CIRCUIT DESIGNATION.

WIRING DEVICES SYMBOLS LEGEND

GROUNDING RECEPTACLE WITH BOX, PLATE & BRANCH CIRCUIT, 120 VOLTS, NEMA 5—20R, MOUNT C.L. UP 18" A.F.F. UNLESS OTHERWISE INDICATED, CIRCUIT DESIGNATION.

D_{*} DUPLEX GROUNDING RECEPTACLE WITH BOX, PLATE & BRANCH CIRCUIT, 120 VOLTS, NEMA 5-20R, MOUNT C.L. UP 18" A.F.F. UNLESS OTHERWISE INDICATED, CIRCUIT DESIGNATION.

DUPLEX GROUNDING RECEPTACLE WITH BOX, PLATE & BRANCH CIRCUIT, G.F.I. TYPE, 120 VOLTS, NEMA 5-20R, MOUNT C.L. UP 18" A.F.F. UNLESS OTHERWISE INDICATED, CIRCUIT DESIGNATION.

DUPLEX GROUNDING RECEPTACLE WITH BOX, WEATHERPROOF COVER & BRANCH CIRCUIT, G.F.I. TYPE, 120 VOLTS, NEMA 5-20R, MOUNT C.L. UP 18" A.F.F. UNLESS NOTED OTHERWISE, CIRCUIT DESIGNATION.

FINAL EQUIPMENT CONNECTION WITH OUTLET BOX, PLATE & BRANCH CIRCUIT, EQUIPMENT AS INDICATED, 120 VOLTS, VERIFY CONNECTION LOCATION WITH EQUIPMENT PROVIDER, CIRCUIT DESIGNATION.

L.V. ELECTRICAL EQUIPMENT SYMBOLS LEGEND

BRANCH CIRCUIT PANELBOARD, SURFACE MOUNT, 208Y/120 VOLT SYSTEM. BRANCH CIRCUIT PANELBOARD, DOUBLE SECTION, SURFACE MOUNT, 208Y/120 VOLT SYSTEM. POWER OR SMALL DISTRIBUTION PANELBOARD, SURFACE MOUNT, 208Y/120 VOLT SYSTEM. JTILITY COMPANY DISCONNECT, NON-FUSED NEMA 3R DISCONNECT SWITCH, AMPERE RATING & NUMBER OF POLES AS INDICATED, NEUTRAL/GROUND BUSES, SURFACE MOUNT PER UTILITY COMPANY SPECS. JTILITY COMPANY METERING EQUIPMENT PER UTILITY COMPANY SPECS FOR ELECTRICAL SERVICE CHARACTERISTICS, NEMA 3R EQUIPMENT, SURFACE MOUNT PER UTILITY COMPANY SPECS. SWITCH, UNFUSED SAFETY DISCONNECT, AMPERE RATING, NUMBER OF POLES, PROPER VOLTAGE RATING FOR BRANCH CIRCUIT, SURFACE MOUNT C.L. UP 54" A.F.F. UNLESS INDICATED OTHERWISE. SWITCH, UNFUSED SAFETY DISCONNECT, NEMA 3R RATED, AMPERE RATING, NUMBER OF POLES, PROPER VOLTAGE RATING FOR BRANCH CIRCUIT, MOUNT C.L. UP 54" A.F.F. UNLESS INDICATED OTHERWISE. SWITCH, FUSED SAFETY DISCONNECT, AMPERE RATING, NUMBER OF POLES, PROPER VOLTAGE RATING FOR BRANCH CIRCUIT, SURFACE MOUNT C.L. UP 54" A.F.F. UNLESS INDICATED OTHERWISE. SWITCH, FUSED SAFETY DISCONNECT, NEMA 3R RATED, AMPERE RATING, NUMBER OF POLES, PROPER VOLTAGE RATING FOR BRANCH CIRCUIT, MOUNT C.L. UP 54" A.F.F. UNLESS INDICATED OTHERWISE. DISCONNECT SWITCH, TOGGLE SWITCH TYPE WITH OUTLET BOX & PLATE, 20A1P, 120/277V, FLUSH MOUNT C.L. UP 48" A.F.F. UNLESS INDICATED OTHERWISE.

DISCONNECT SWITCH, TOGGLE SWITCH TYPE WITH OUTLET BOX & PLATE, 20A2P, 120/277V, FLUSH MOUNT C.L.

E R

G

ENGINEERING

RESOURCE GROUP
350 EDGEWOOD TERRACE DRIVE
JACKSON, MS 39206
PHONE: (601) 362-3552
FAX: (601) 366-6418

CONSULTANTS:

ELECTRICAL ENGINEER SCHULTZ & WYNNE, P.A 4523 OFFICE PARK DR. JACKSON, MS 39206 T: (601) 982-3313

PROJECT:

HVAC UPGRADES LAUDERDALE COUNTY ANIMAL SHELTER

EAL

M. WYN

MINISTER

#11869

THE MINISTER

OF MISSIER


OR (19/2024)

SHEET TITLE:

ELECTRICAL DRAWING

SHEET NUMBER

E101

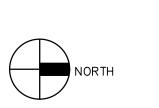

Schultz & Wynne

Consulting Electrical Engineers

A PROFESSIONAL ASSOCIATION

4523 Office Park Drive Phone: 601-982-3313

UP 48" A.F.F. UNLESS INDICATED OTHERWISE.

Fax: 601-982-7685

S/W JOB NO: 222076

Jackson, MS 39206